


# PROPOSED EXTERIOR BUILDING RENOVATIONS


## 2651 STRANG BOULEVARD

### YORKTOWN HEIGHTS, NEW YORK 10598

ZONE DISTRICT: OB / SECTION: 26.19 / BLOCK: 1 / LOT: 2

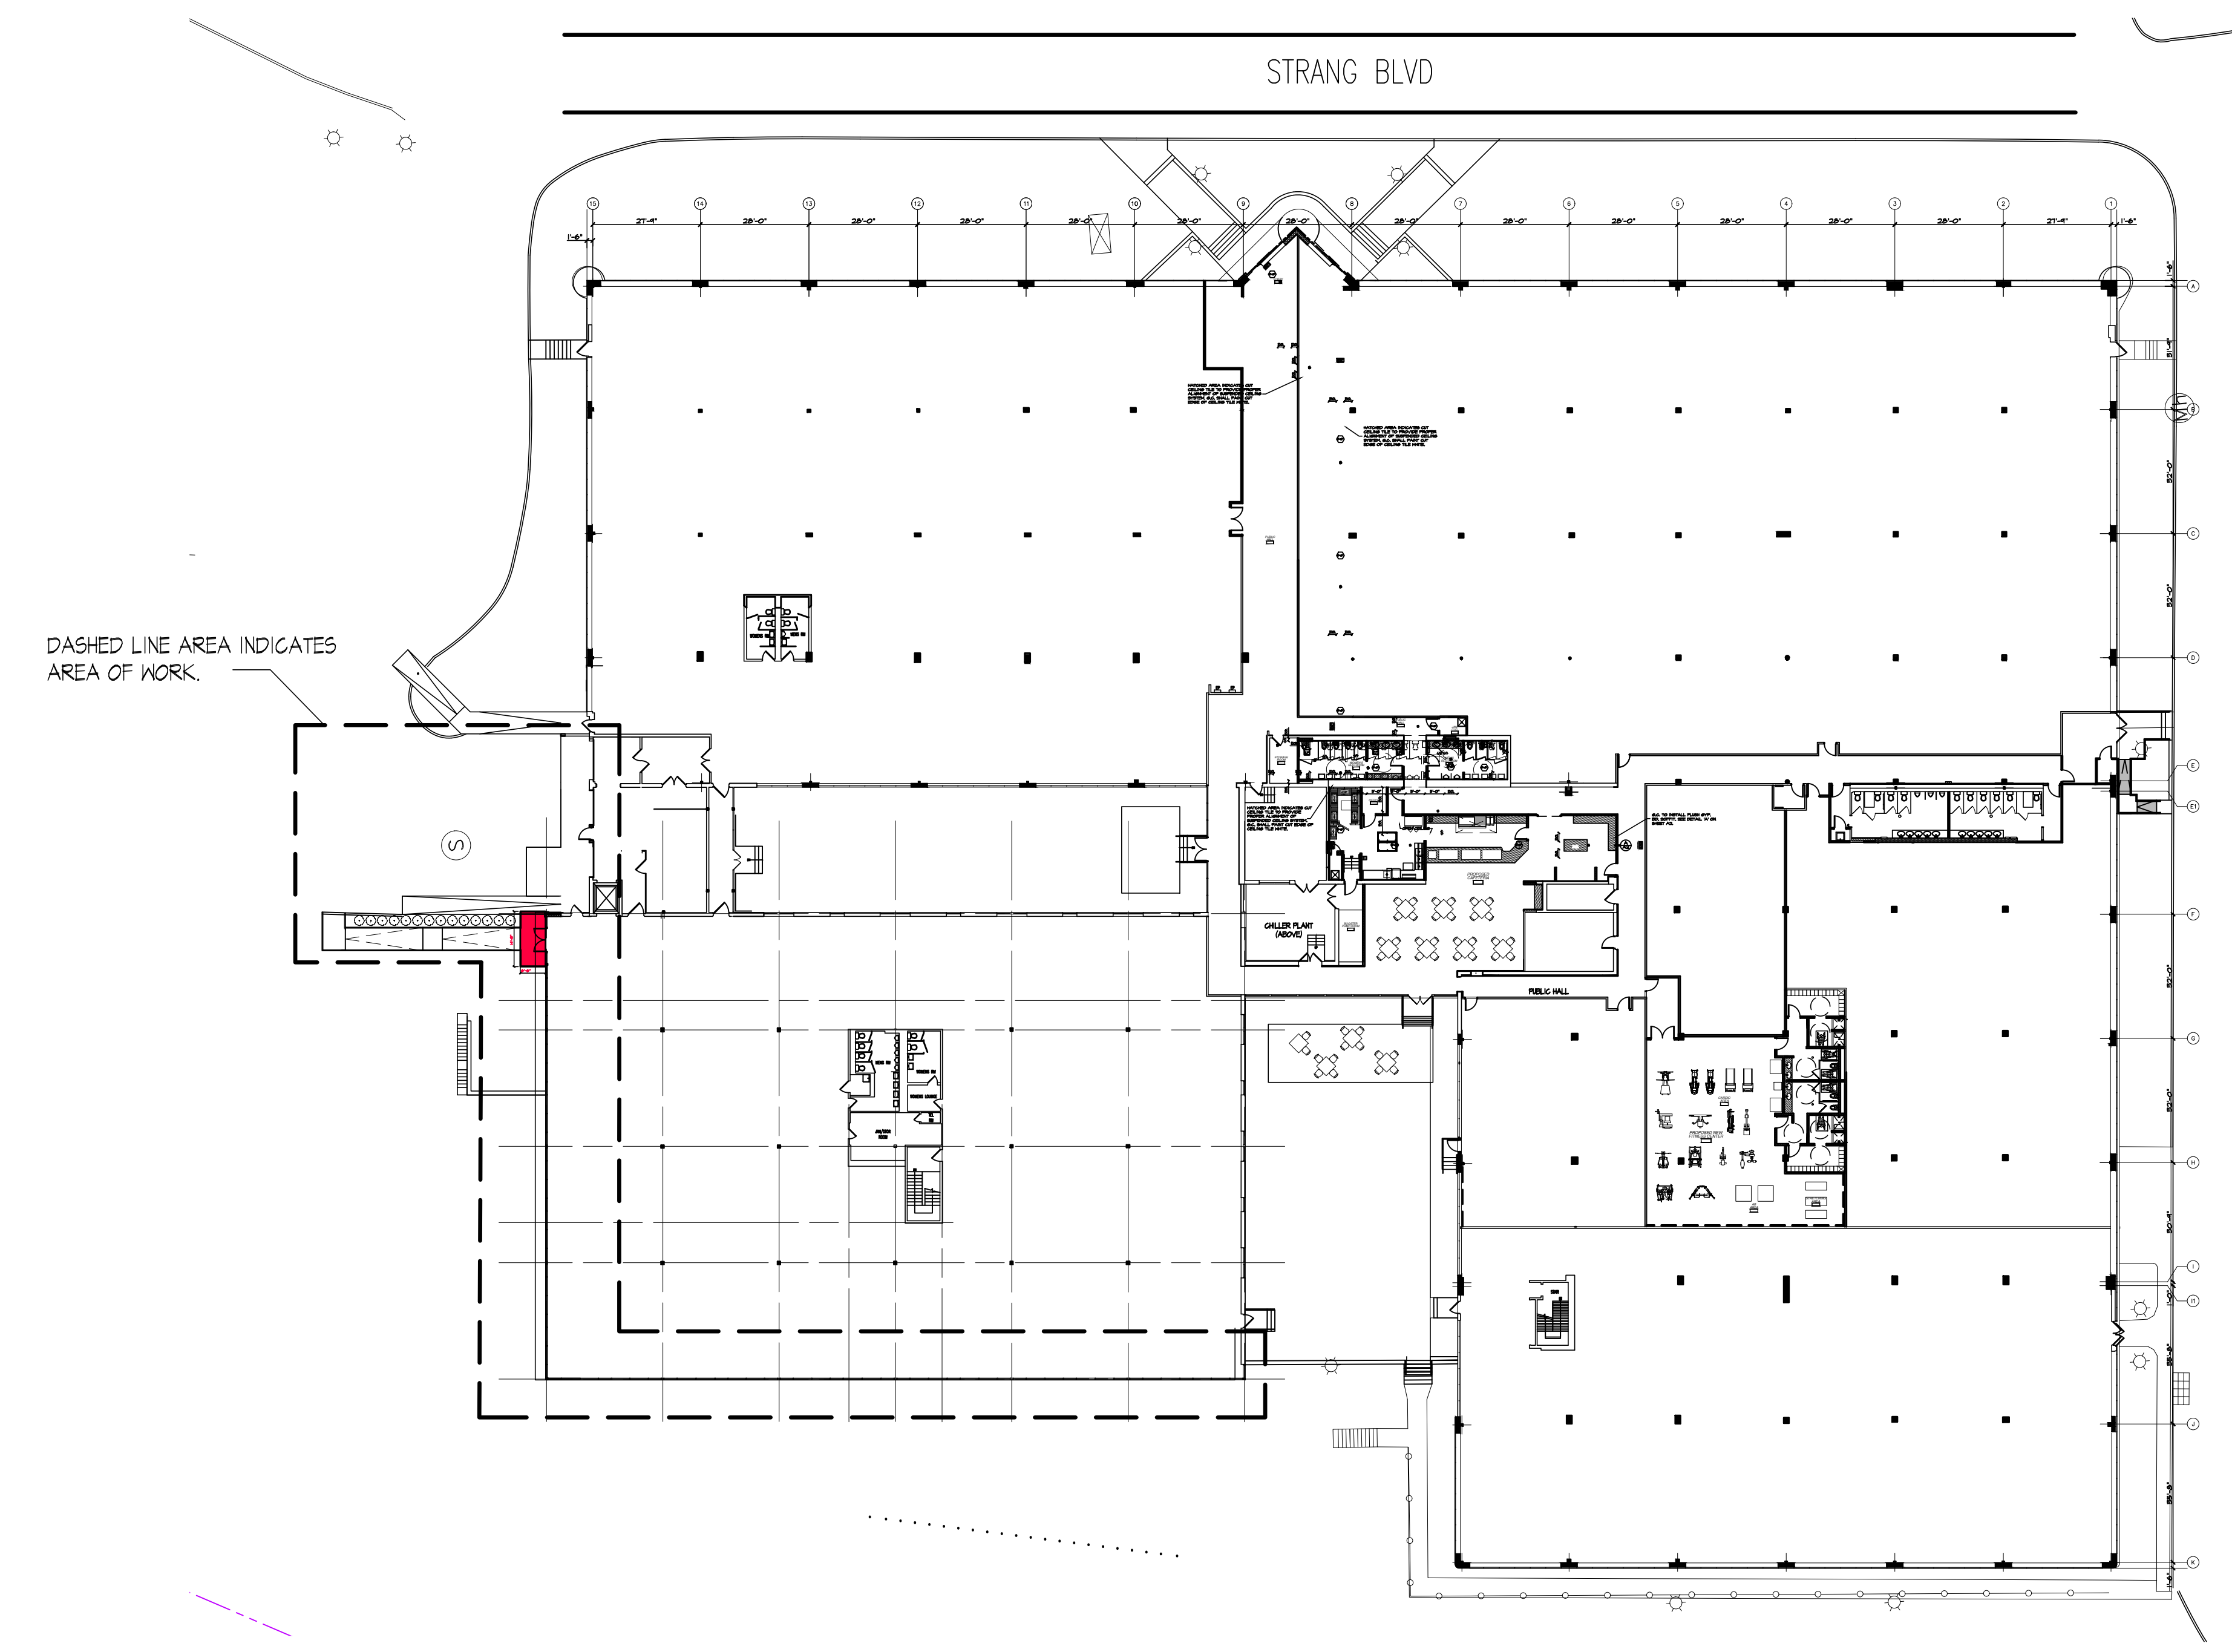

① 1ST FLOOR KEY PLAN  
SCALE: N1/2"

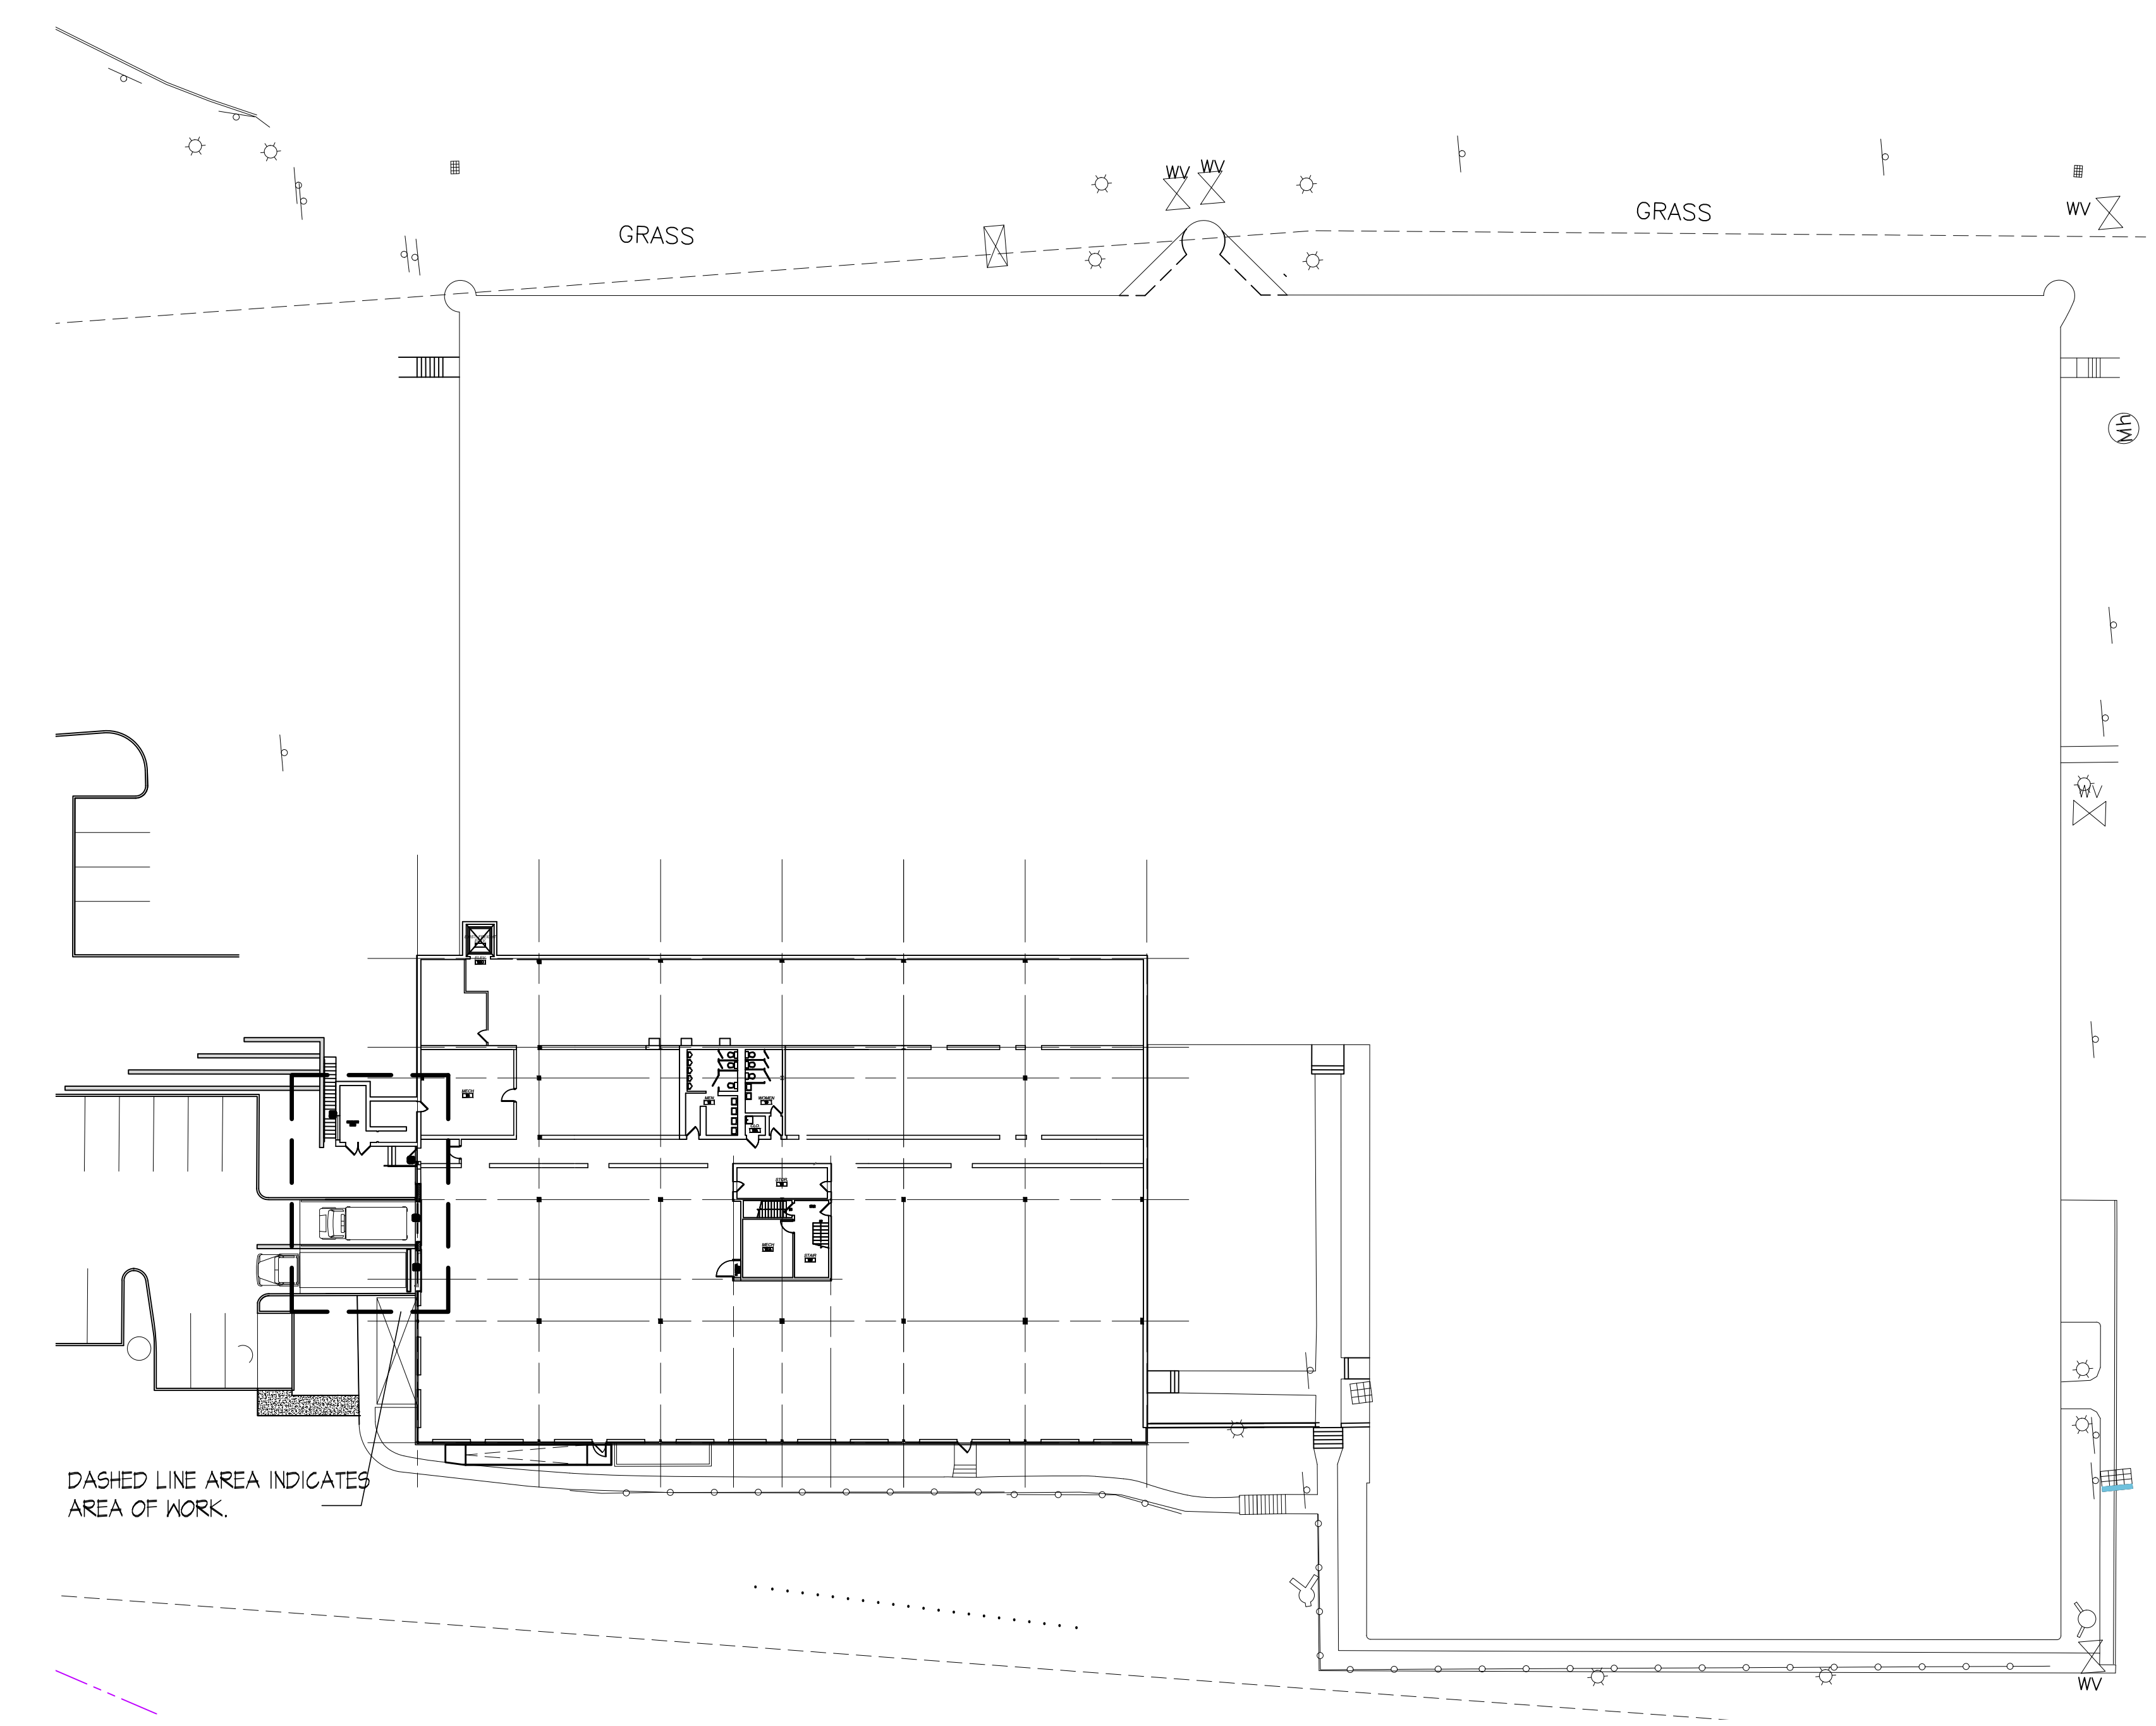


② LOWER FLOOR KEY PLAN  
SCALE: N1/2"

DRAWING LIST	
<b>ARCHITECTURAL DRAWINGS</b>	
COVER SHEET	A-0
DEMOLITION PLAN	D-01
CONSTRUCTION PLAN	A-1
FOUNDATION PLAN	A-2
ELEVATIONS	A-3
ELEVATIONS	A-4
WALL SECTIONS	A-5
RETAINING WALL DETAILS	A-6
EXTERIOR LIGHTING LAYOUT	A-7

PROJECT: PROPOSED EXTERIOR BUILDING RENOVATIONS  
 2651 STRANG BOULEVARD  
 YORKTOWN HEIGHTS, NEW YORK 10598  
 GROUND FLOOR  
 ZONE DISTRICT: OB / SECTION: 26.19 / BLOCK: 1 / LOT: 2

NO.	DATE	DESCRIPTION
1.	06/17/21	ISSUE FOR PLANNING BOARD REVIEW
2.	07/27/21	ISSUE FOR PLANNING BOARD REVIEW
3.	09/22/21	ISSUE FOR PLANNING BOARD REVIEW



SCALE: AS NOTED    DATE: 05/17/21    PROJECT NO.: 21-000-00

DRAWN BY: A.M.    CHECKED BY:    APPROVED BY:   

DRAWING TITLE: **COVER SHEET**


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NO.	DATE	DESCRIPTION
1.	06/12/21	ISSUE FOR PLANNING BOARD REVIEW
2.	07/22/21	ISSUE FOR PLANNING BOARD REVIEW
3.	09/22/21	ISSUE FOR PLANNING BOARD REVIEW

DATE	DATE	PROJECT NO.
AS NOTED	05/17/21	21-000-00
DRAWN BY:	CHECKED BY:	APPROVED BY:
A.M.		
DRAWING TITLE: <b>DEMOLITION PLAN</b>		


- EXISTING PARTITION TO REMAIN.
- - - EXISTING PARTITION TO BE REMOVED.
- (K) EXISTING DOORS, FRAMES AND HARDWARE TO BE REMOVED. COORDINATE WITH CLIENT FOR STORAGE.
- (E) EXISTING DOORS, FRAMES AND HARDWARE TO BE REMOVED. COORDINATE WITH CLIENT FOR STORAGE.

- DEMOLITION GENERAL NOTES**
- THE CONTRACTOR SHALL FURNISH ALL LABOR, MATERIALS AND EQUIPMENT AS REQUIRED TO COMPLETE DEMOLITION AND REMOVAL OF ALL ITEMS SHOWN ON DRAWINGS.
  - ALL DEMOLITION DEBRIS SHALL BE REMOVED FROM THE PREMISES EXCEPT THOSE ITEMS TO BE REUSED, RETURNED TO THE LANDLORD / OWNER OR AS OTHERWISE DIRECTED.
  - THE CONTRACTOR SHALL CAREFULLY REMOVE, PROTECT AND STORE ALL CONSTRUCTION ELEMENTS TO BE REUSED OR RETURNED TO THE LANDLORD / OWNER.
  - UPON COMPLETION OF THE DEMOLITION WORK, ALL AREAS SHALL BE BROOM CLEAN.
  - ALL CORE AREAS, ELEVATOR LOBBIES, TOILETS, STAIRWELLS AND EXISTING ELEMENTS TO REMAIN SHALL BE CAREFULLY SEALED AND PROTECTED FROM DAMAGE AND DIRT.
  - ALL PERIMETER FAN COIL AND EQUIPMENT, RADIATOR, ENGINE AND AIRWAYS SHALL BE CAREFULLY COVERED AND PROTECTED FROM GRIT, RUBBISH AND DAMAGE.
  - WHERE EXISTING SWITCHES, OUTLETS AND PHONE / DATA OUTLETS ARE REMOVED, G.C. SHALL PATCH SPACKLE AND SAND SMOOTH WALL FOR PAINT. NO COVER PLATES SHALL BE USED.
  - ALL ELECTRICAL AND LIGHTING TO BE DEMOLISHED AND ASSOCIATED WIRING SHALL BE PULLED BACK TO THE ELECTRICAL PANELS AND REMOVED COMPLETELY.
  - ALL DEMOLITION WORK SHALL BE PERFORMED BEFORE OR AFTER BUSINESS HOURS, UNLESS OTHERWISE PERMITTED BY THE BUILDING MANAGER AND / OR THE CLIENT.
  - IN ALL AREAS WHERE DEMOLITION OR CUTS AND PATCHES CAUSE A UNEVENNESS IN THE SLAB, THE CONTRACTOR SHALL FLASH PATCH AS REQUIRED TO RECEIVE THE NEW FLOOR FINISH. COORDINATE WITH FLOORING CONTRACTOR.
  - THE GENERAL CONTRACTOR SHALL ERECT A PLASTIC DUST PARTITION TO PROTECT AREAS NOT INCLUDED IN THE SCOPE OF WORK.
  - PRIOR TO DEMOLITION THE CONSTRUCTION AREA SHALL BE INSPECTED FOR PRESENCE OF ASBESTOS. IF PRESENT IT SHALL BE REMOVED IN COMPLIANCE WITH THE STATE OF NEW YORK, REQUIREMENTS AND FEDERAL NESHAP NATIONAL EMISSION STANDARDS FOR HAZARDOUS AIR POLLUTANTS REGULATION. (NESHAP - PHONE: 1-212-407-4000)
  - WHERE REMOVALS ARE NOT POSSIBLE WITHOUT DAMAGE OF EXISTING TO REMAIN, G.C. SHALL REPAIR OR REPLACE DAMAGED ITEMS AS REQUIRED.

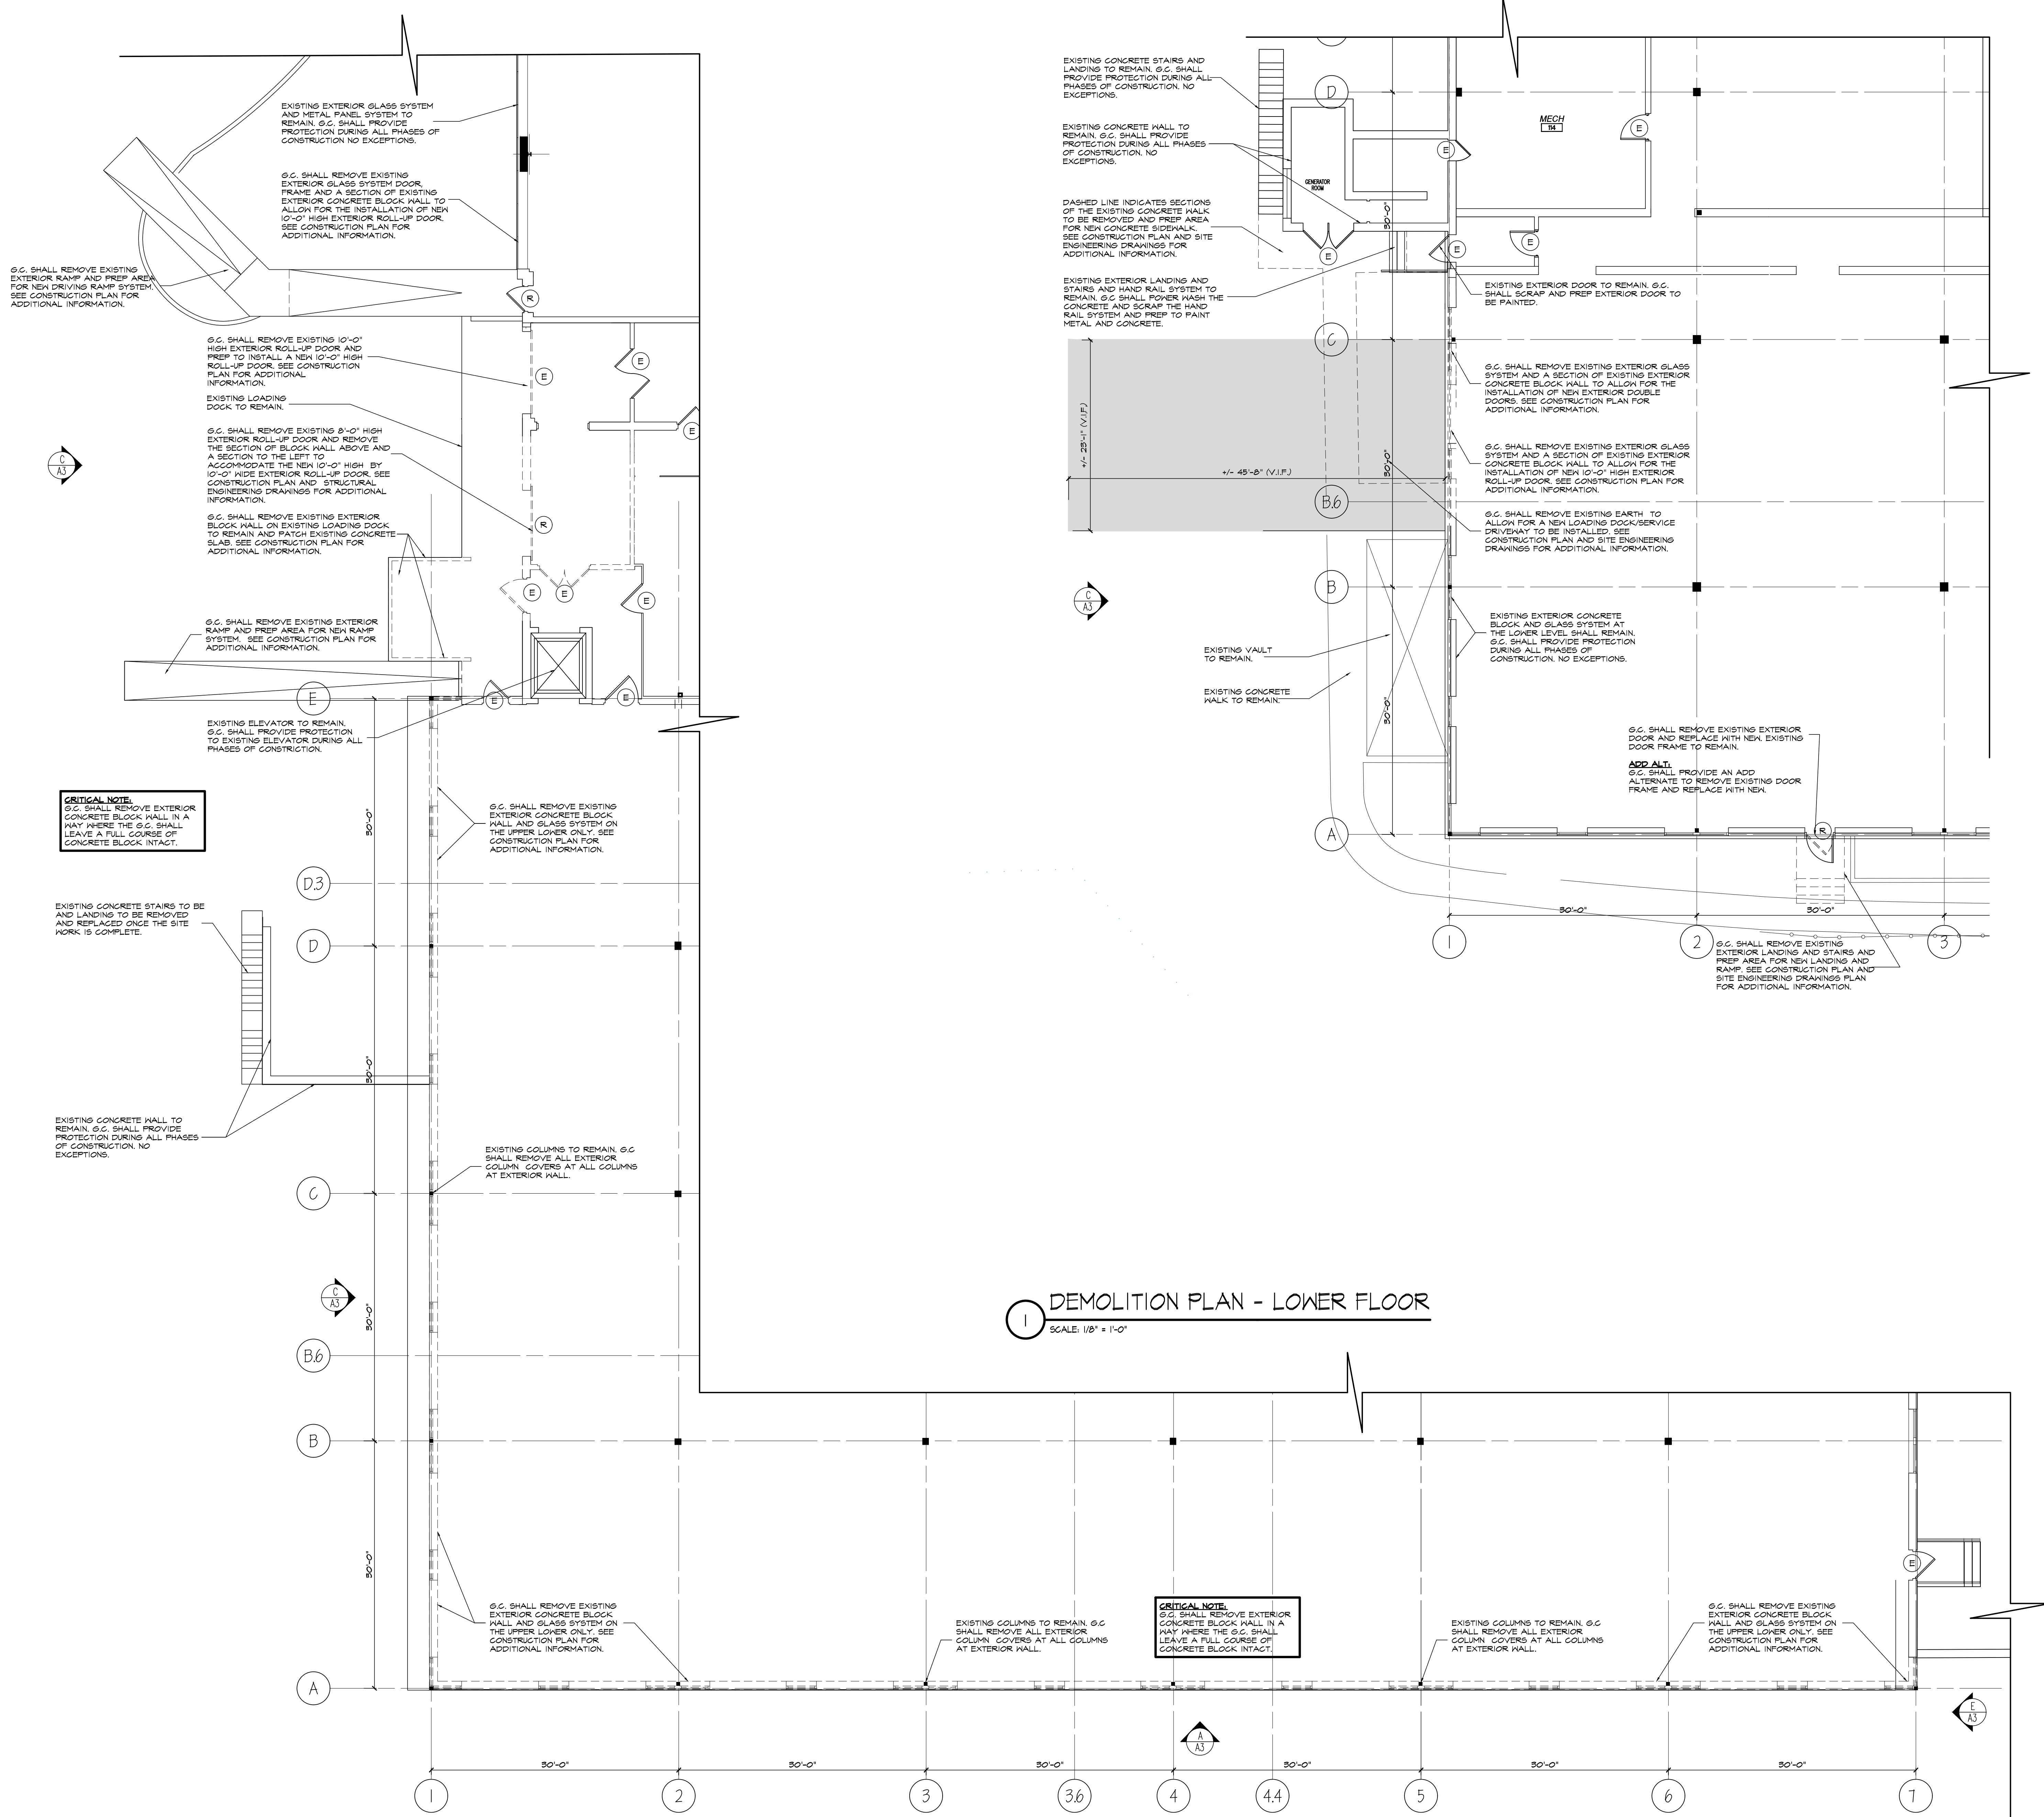

**1 DEMOLITION PLAN - LOWER FLOOR**  
SCALE: 1/8" = 1'-0"


**2 DEMOLITION PLAN - UPPER FLOOR**  
SCALE: 1/8" = 1'-0"

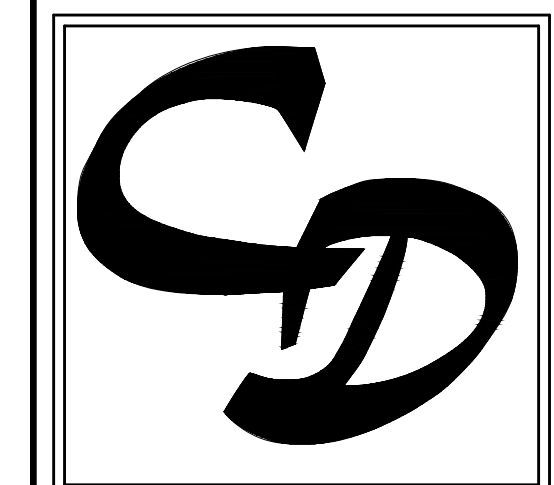


CARDARELLI  
DESIGN & ARCHITECTURE, P.C.  
297 KNOLLWOOD ROAD, SUITE 202  
WHITE PLAINS, NY 10607  
PHONE: 914-437-9554 / FAX: 914-437-9555



PROJECT:  
**PROPOSED EXTERIOR BUILDING RENOVATIONS**  
**2651 STRANG BOULEVARD**  
**YORKTOWN HEIGHTS, NEW YORK 10598**  
**GROUND FLOOR**  
ZONE DISTRICT: OB / SECTION: 26.19 / BLOCK: 1 / LOT: 2

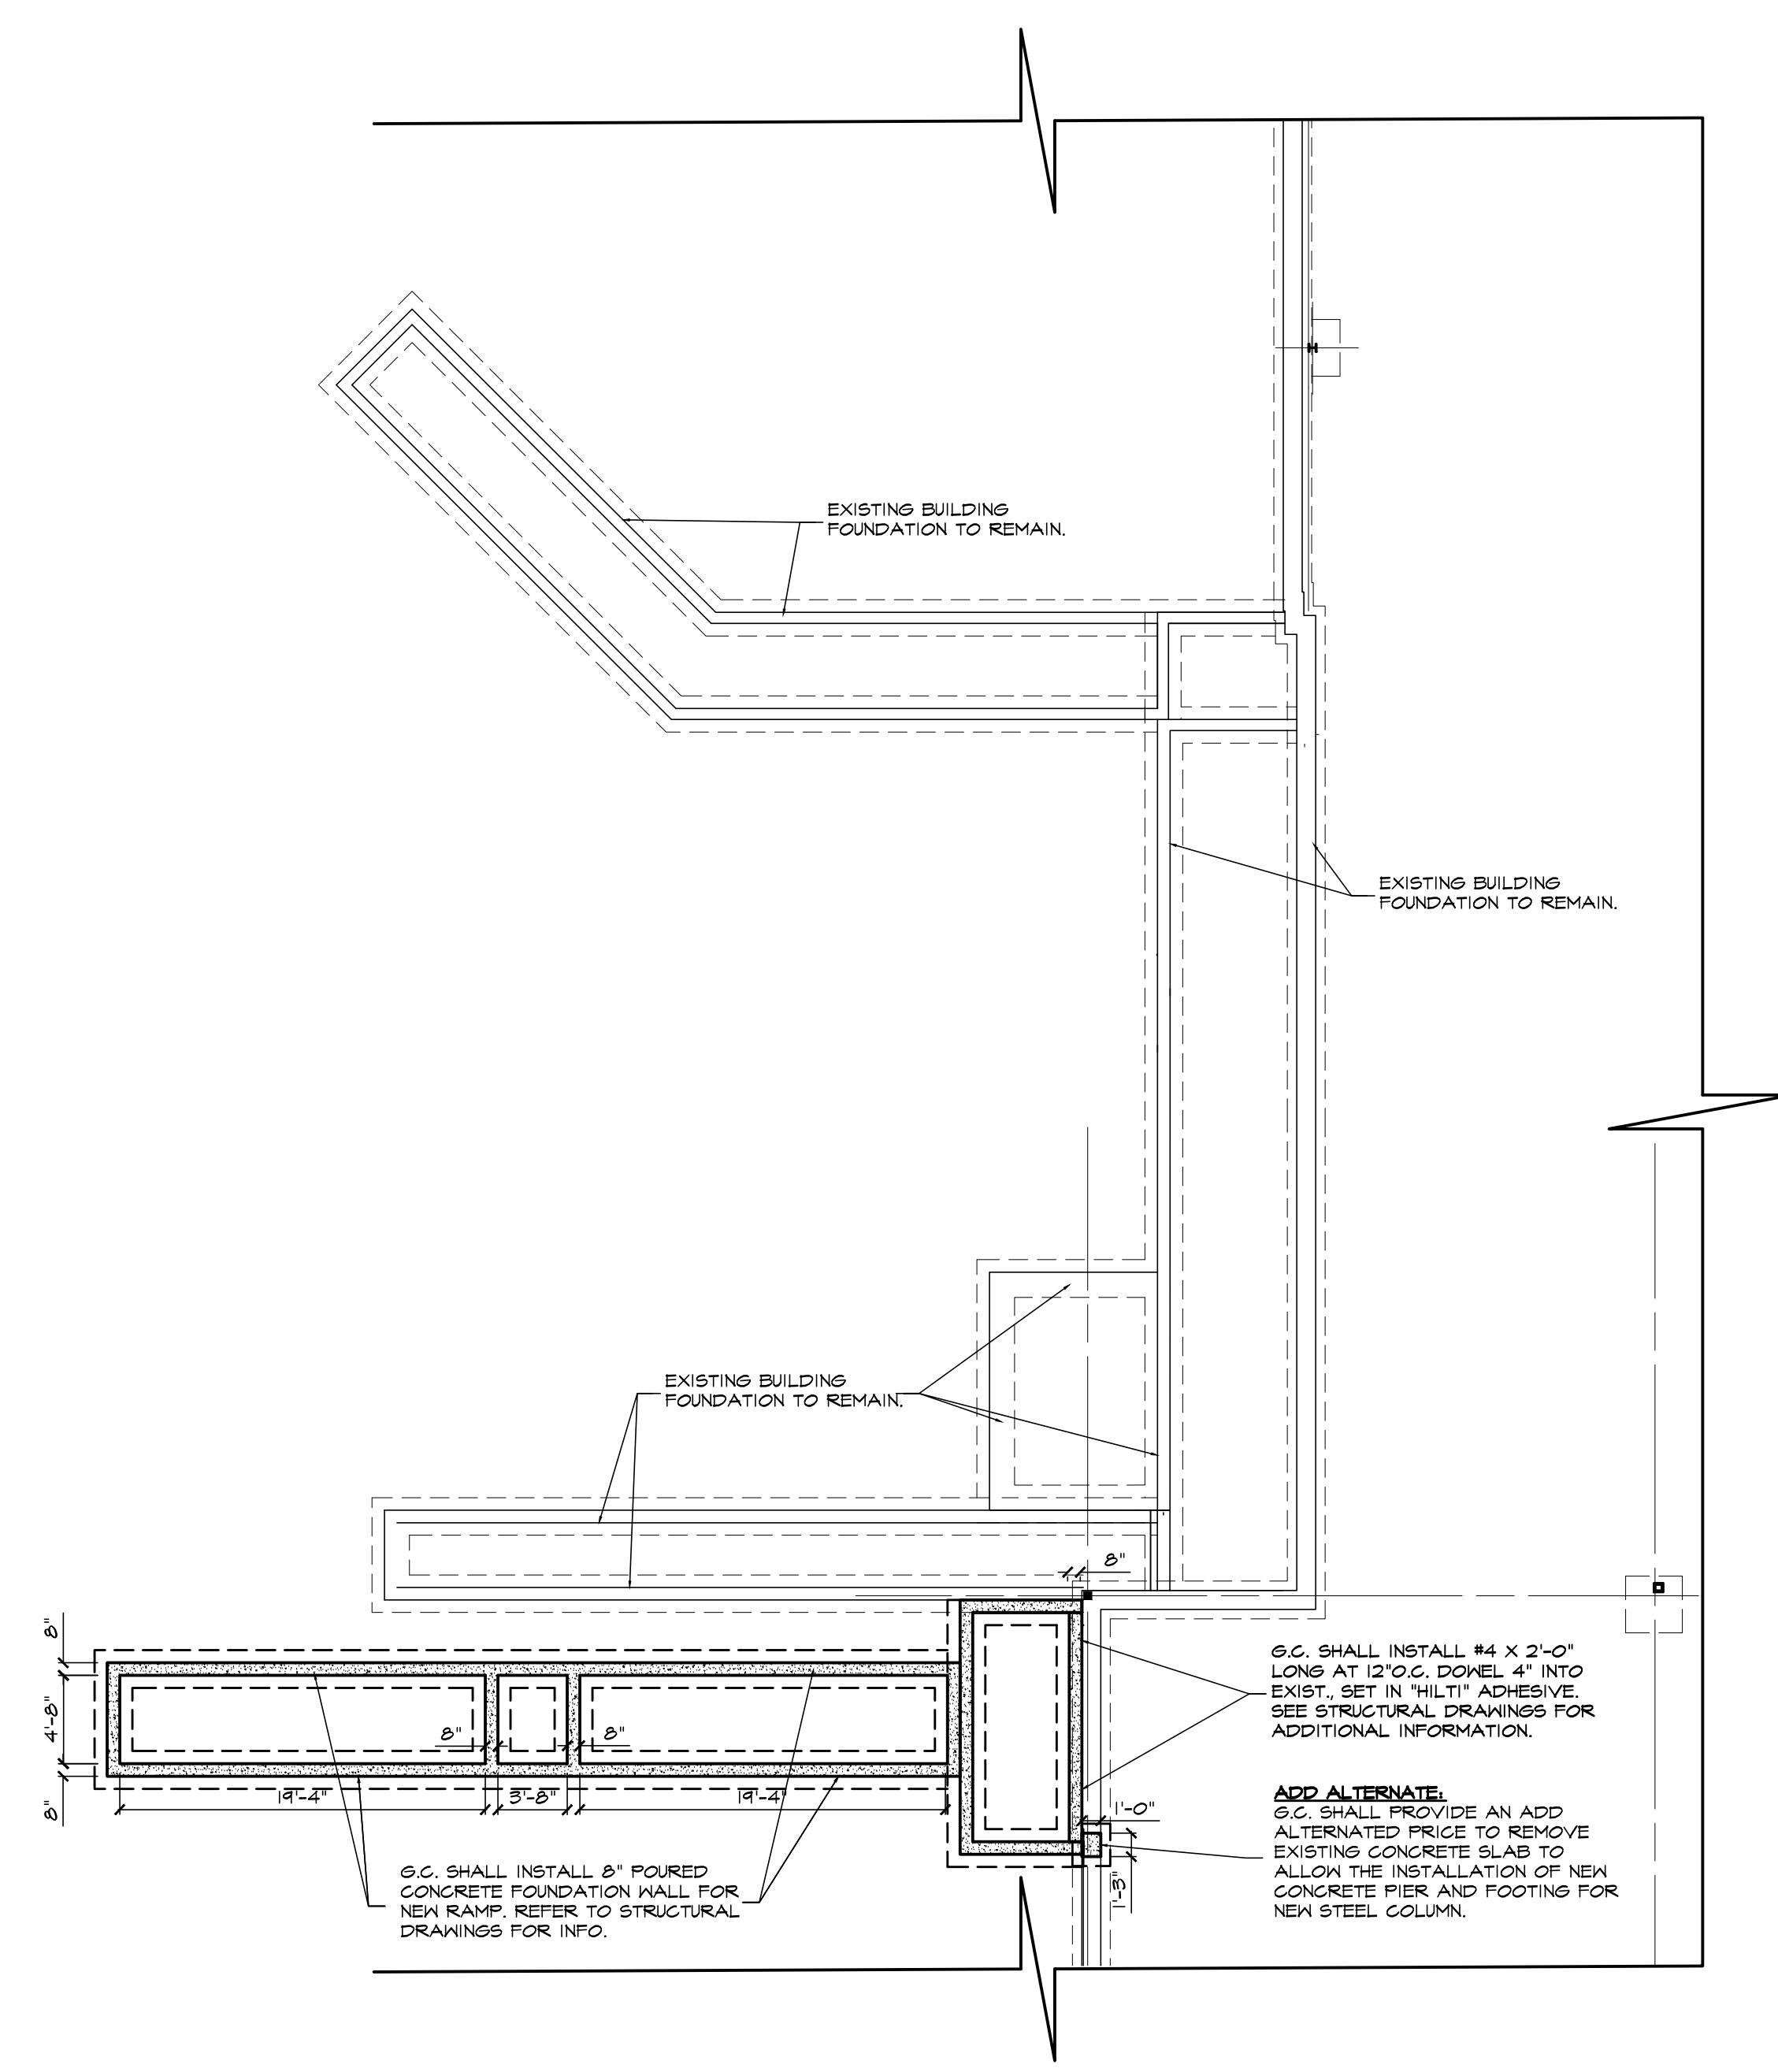

**2** FOUNDATION PLAN - UPPER FLOOR  
SCALE: 1/8" = 1'-0"

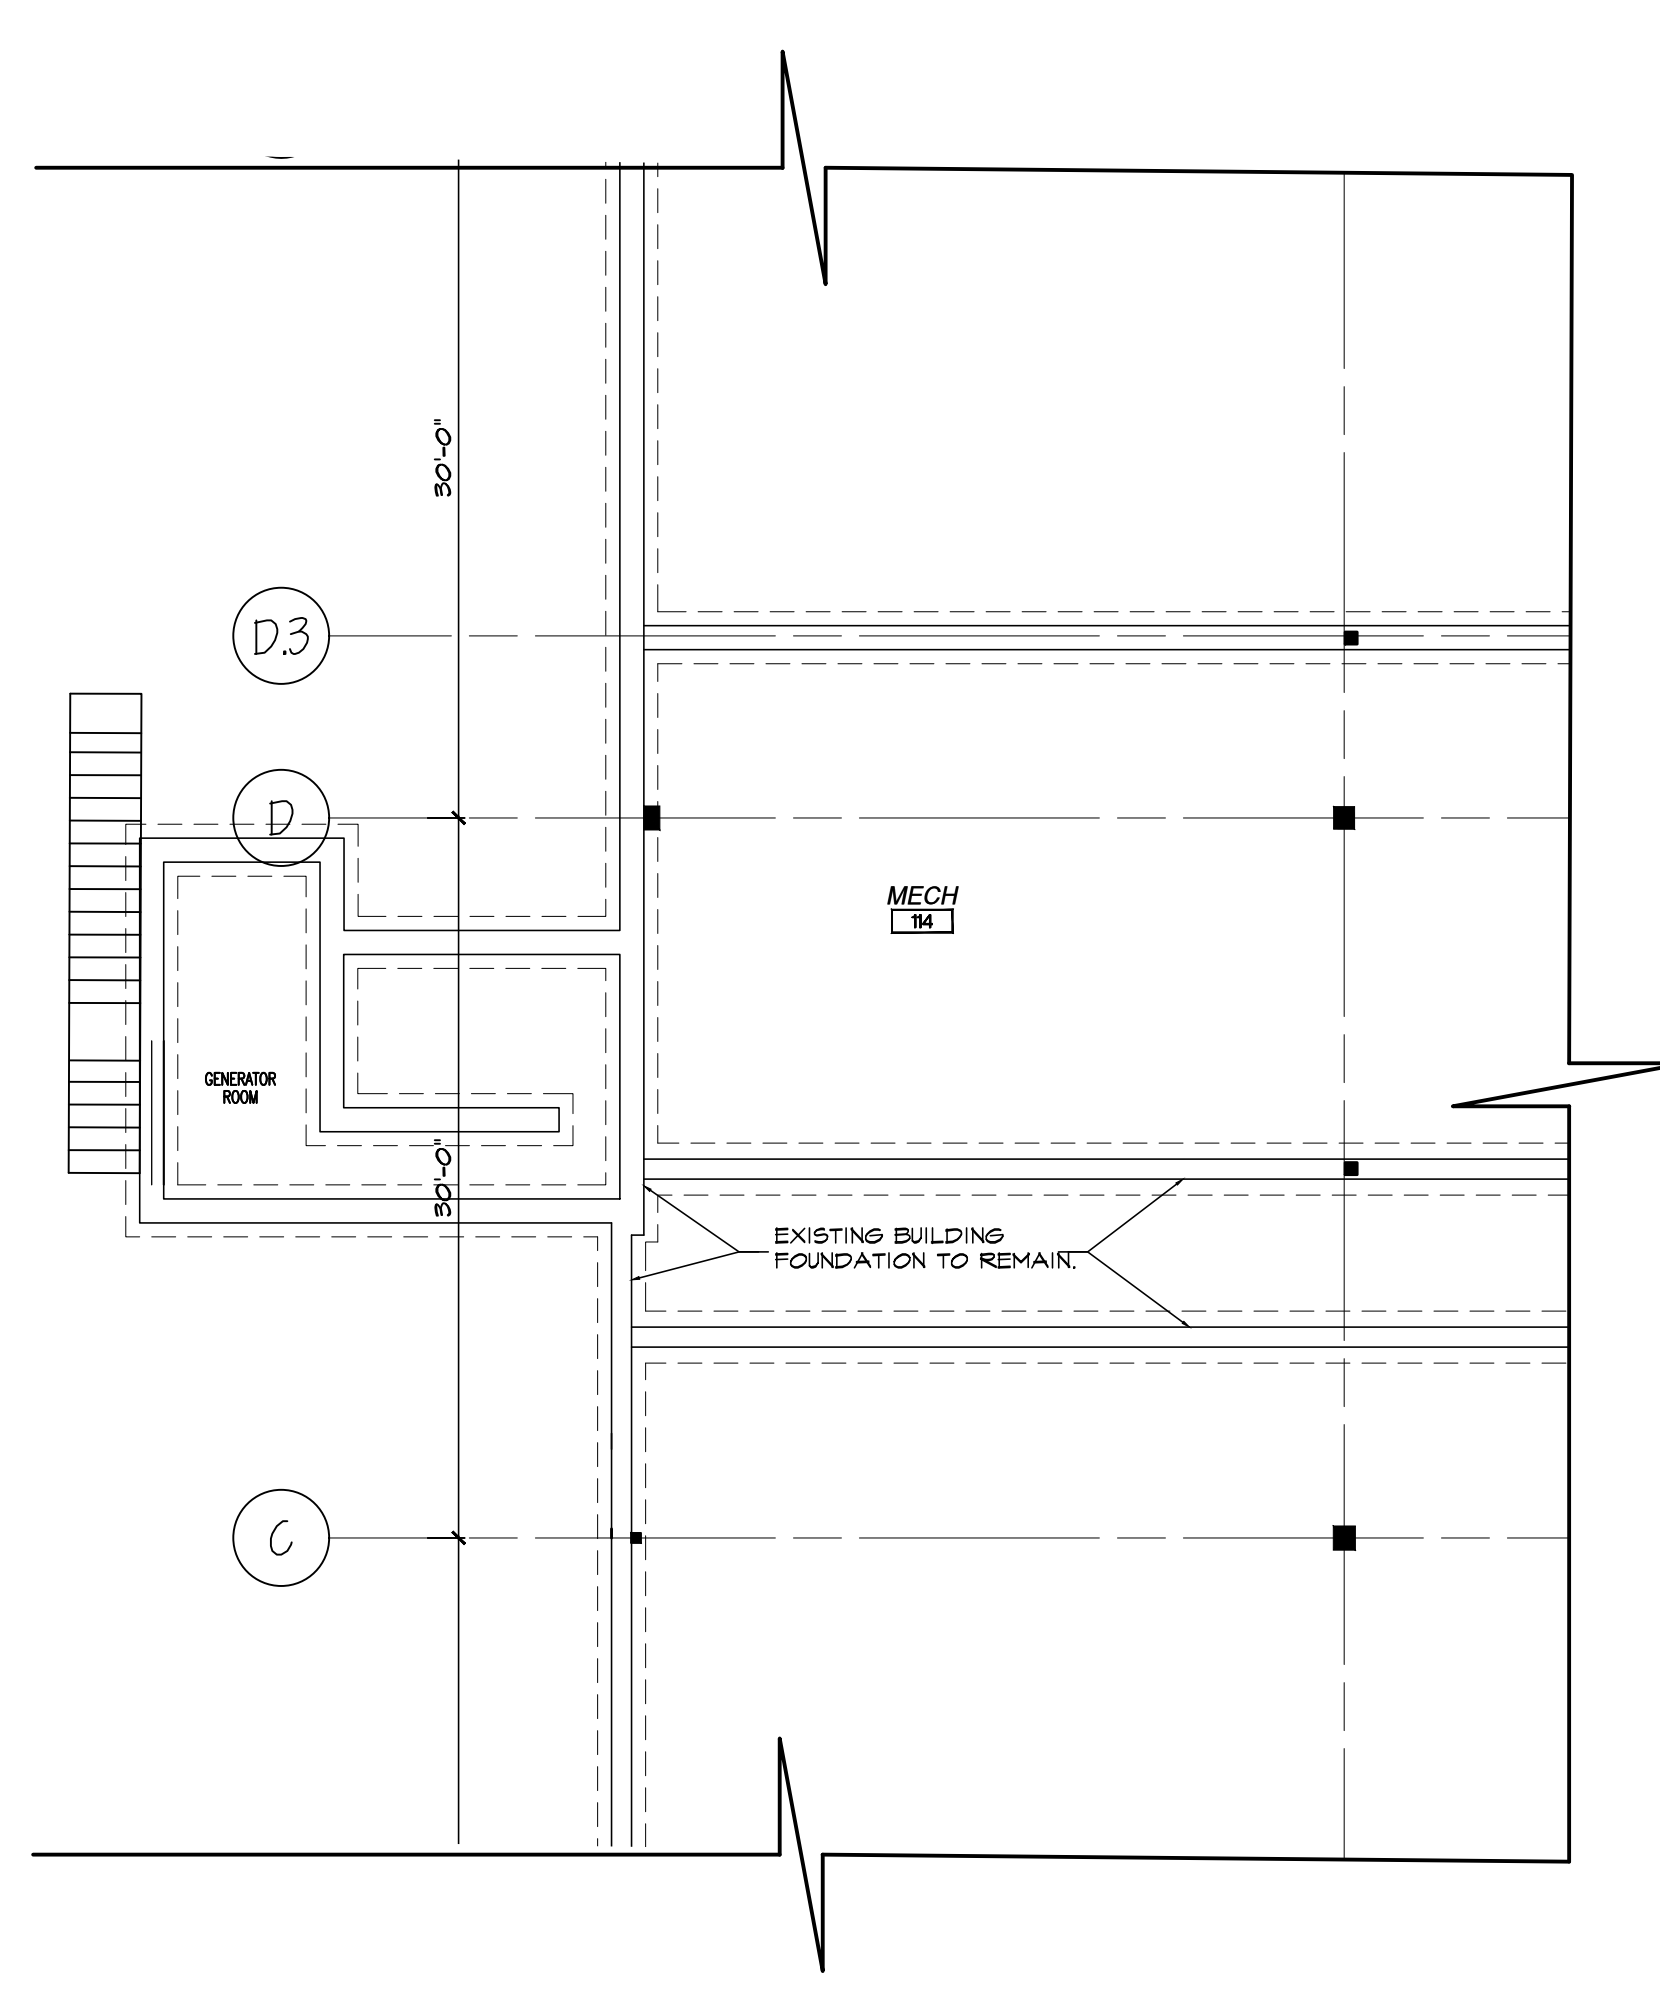

**1** FOUNDATION PLAN - LOWER FLOOR  
SCALE: 1/8" = 1'-0"


NO.	DATE	DESCRIPTION
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SCALE: AS NOTED  
DATE: 05/17/21  
PROJECT NO.: 21-000-00  
DRAWN BY: A.M.  
CHECKED BY:  
APPROVED BY:  
DRAWING TITLE:  
**FOUNDATION PLAN**

DRAWING NO.: **AI**

**PROPOSED EXTERIOR BUILDING RENOVATIONS**  
**2651 STRANG BOULEVARD**  
**YORKTOWN HEIGHTS, NEW YORK 10598**  
**GROUND FLOOR**  
 ZONE DISTRICT: OB / SECTION: 26.19 / BLOCK: 1 / LOT: 2



**1 CONSTRUCTION PLAN - LOWER FLOOR**  
 SCALE: 1/8" = 1'-0"

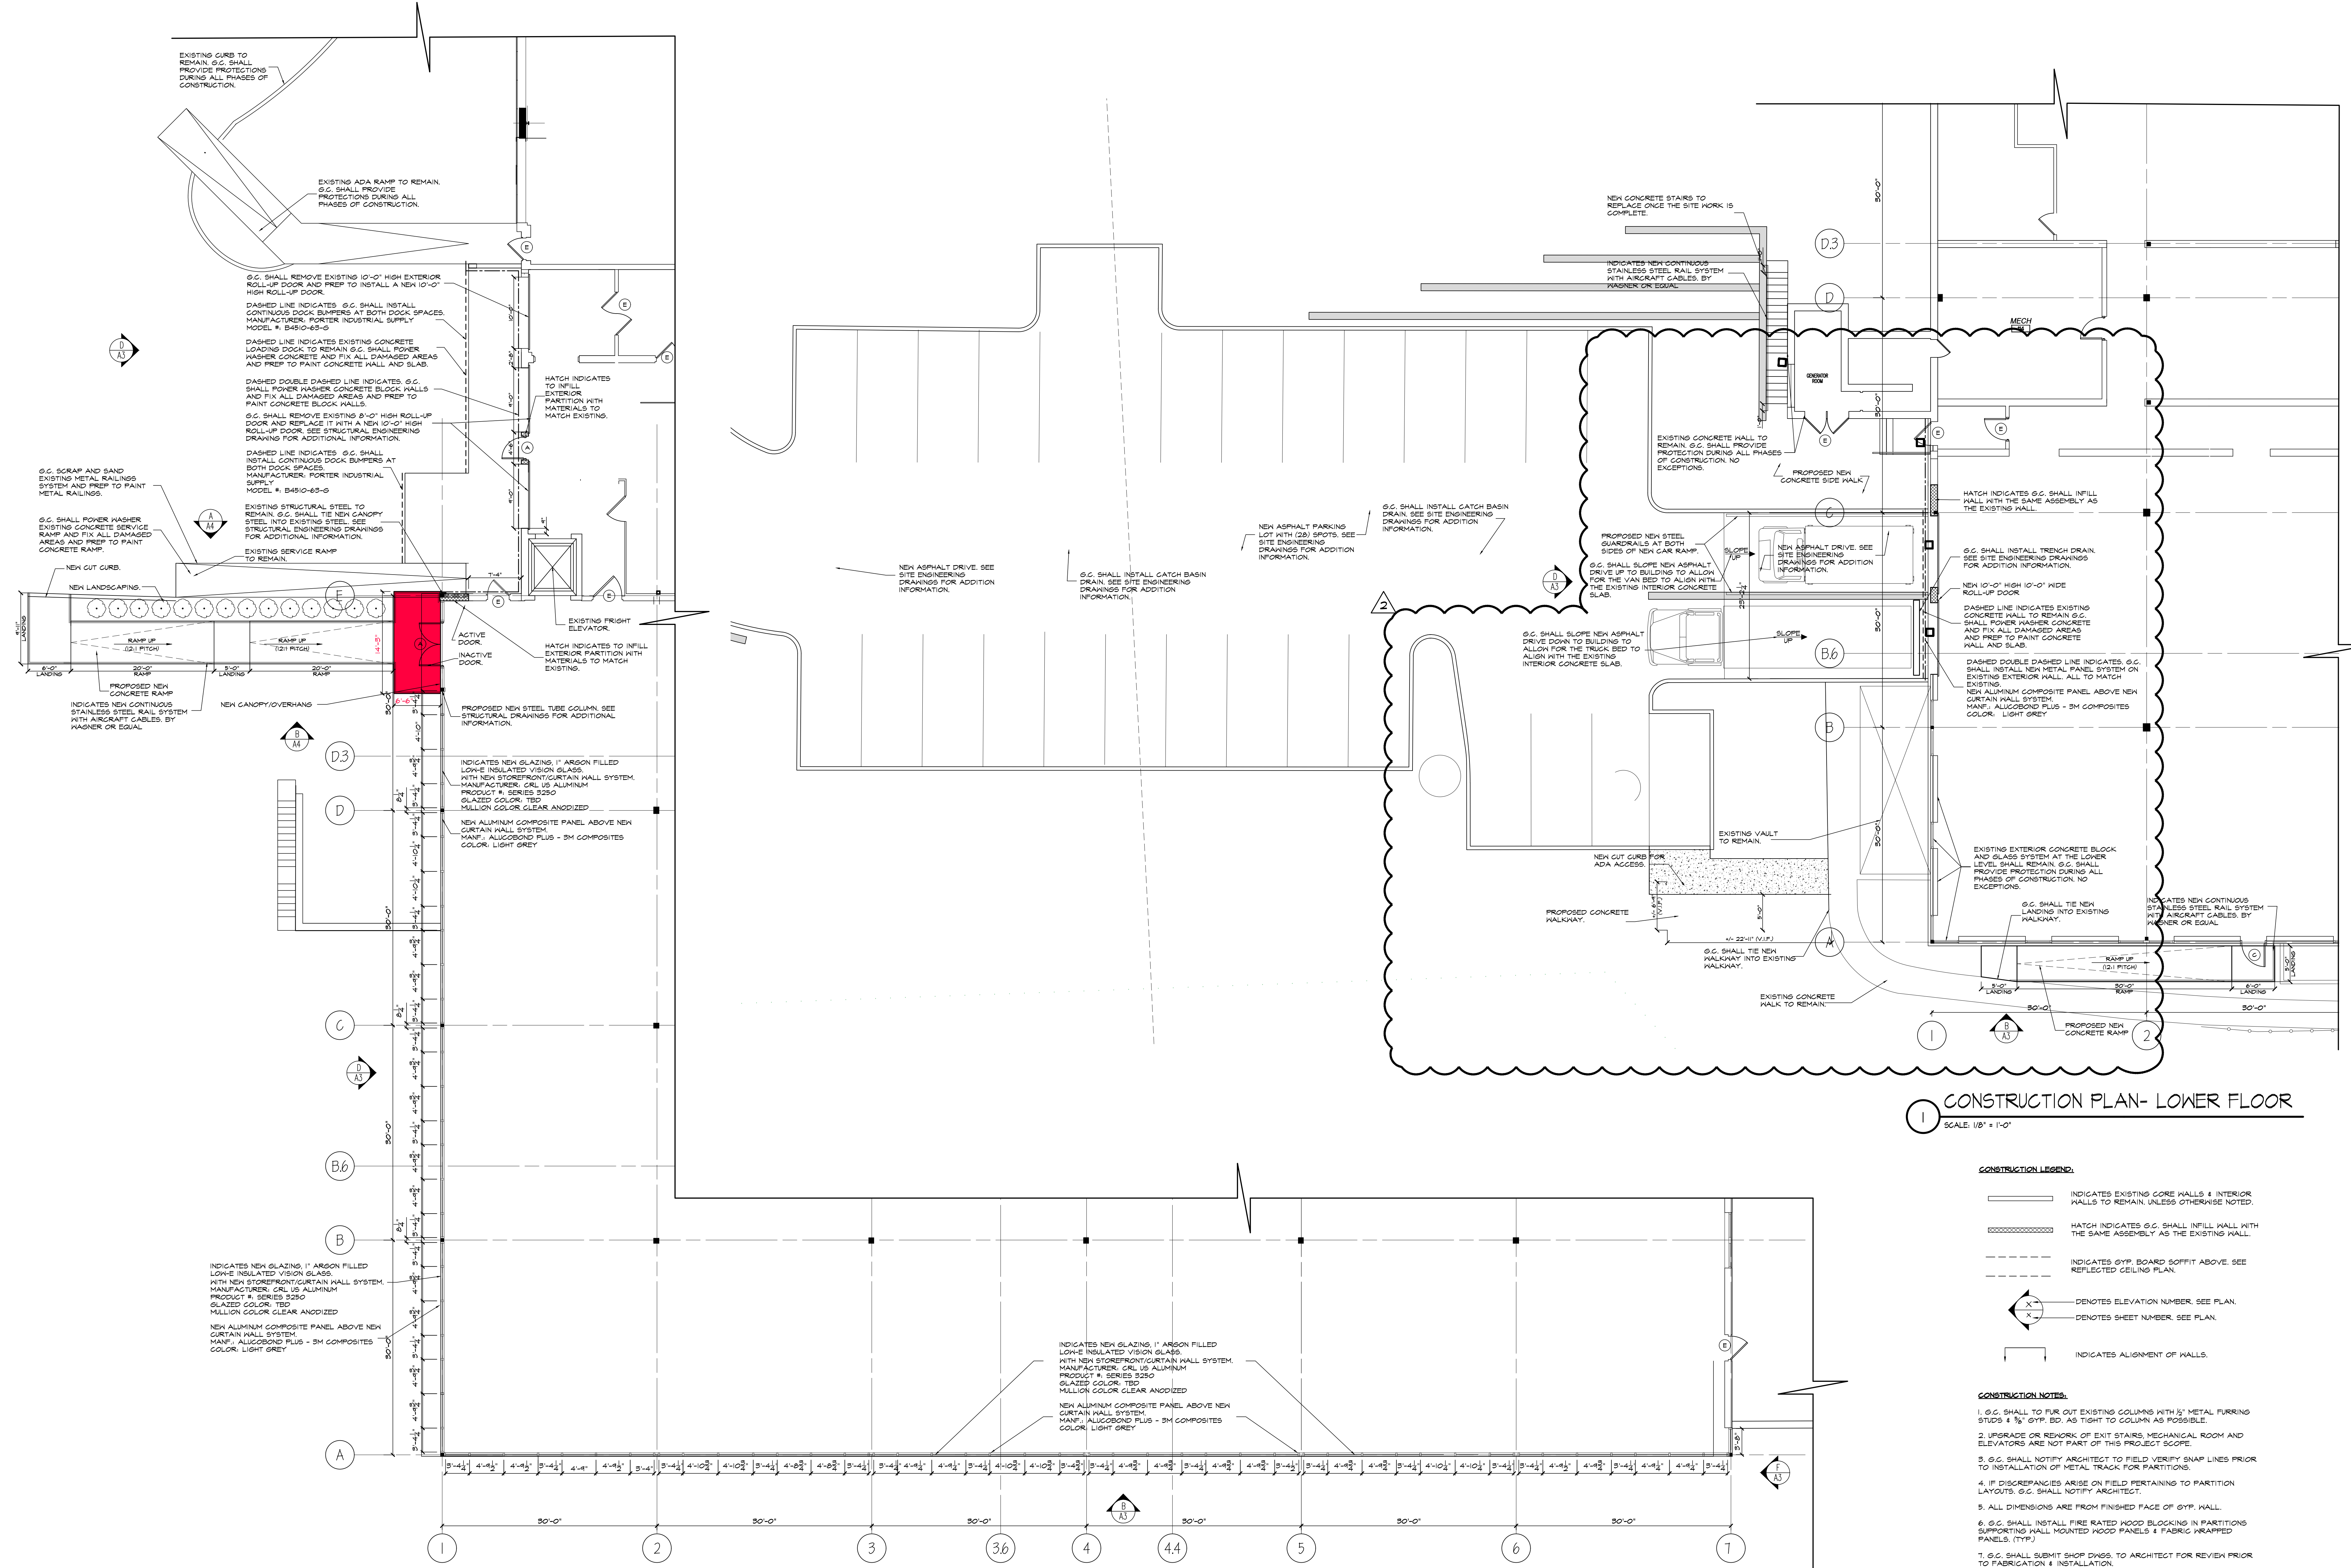- CONSTRUCTION LEGEND:**
- INDICATES EXISTING CORE WALLS & INTERIOR WALLS TO REMAIN UNLESS OTHERWISE NOTED.
  - HATCH INDICATES G.C. SHALL INFILL WALL WITH THE SAME ASSEMBLY AS THE EXISTING WALL.
  - - - - - INDICATES GYP. BOARD SOFFIT ABOVE. SEE REFLECTED CEILING PLAN.
  - X — DENOTES ELEVATION NUMBER. SEE PLAN.
  - DENOTES SHEET NUMBER. SEE PLAN.
  - INDICATES ALIGNMENT OF WALLS.

- CONSTRUCTION NOTES:**
1. G.C. SHALL FUR OUT EXISTING COLUMNS WITH 3" METAL FURRING STUDS & 3/4" GYP. BD. AS TIGHT TO COLUMN AS POSSIBLE.
  2. UPGRADE OR REWORK OF EXIT STAIRS, MECHANICAL ROOM AND ELEVATORS ARE NOT PART OF THIS PROJECT SCOPE.
  3. G.C. SHALL NOTIFY ARCHITECT TO FIELD VERIFY SHAP FINISH PRIOR TO INSTALLATION OF METAL TRACK FOR PARTITIONS.
  4. IF DISCREPANCIES ARISE ON FIELD PERTAINING TO PARTITION LAYOUTS, G.C. SHALL NOTIFY ARCHITECT.
  5. ALL DIMENSIONS ARE FROM FINISHED FACE OF GYP. WALL.
  6. G.C. SHALL INSTALL FIRE RATED HOOD BLOCKING IN PARTITIONS SUPPORTING WALL MOUNTED HOOD PANELS & FABRIC FRAMED PANELS. (TYP)
  7. G.C. SHALL SUBMIT SHOP DRAWINGS TO ARCHITECT FOR REVIEW PRIOR TO FABRICATION & INSTALLATION.
  8. G.C. SHALL SUBMIT ALL MILLWORK FINISH SAMPLES IN TRAY TO ARCHITECT FOR REVIEW & TENANT SIGN-OFF.
  9. G.C. SHALL PATCH AND SCUM COAT ALL EXISTING CORE WALLS AND PREP TO RECEIVE NEW FINISHES.
  10. EXISTING CORE WALLS TO BE SCUM COAT WALLS TO LEVEL 3 FINISH AND PREP TO RECEIVE NEW FINISHES.

**2 CONSTRUCTION PLAN - UPPER FLOOR**  
 SCALE: 1/8" = 1'-0"

**DOOR FRAME AND HARDWARE SCHEDULE:**

**DOOR AND FRAME TYPE:**  
 INDICATES (1) PAIR 3'-0" X 7'-0" X 1 3/4" KAWNEER FLUSHLINE ENTRANCES. ALUMINUM FRAMED VISION LITES. TYPE AVL-4, 6' X 32" LOCK SIDE PLACEMENT 1" FROM TOP OF DOOR AND JAMB. PLAIN ALUM. SHEET EXTERIOR AND INTERIOR. COLOR AND FINISH TO MATCH STOREFRONT FRAMING.

**HARDWARE TYPE:**  
 KAWNEER STANDARD EXIT DEVICE, DUR-O-MATIC / PALCON 1790 EXTERIOR FULL STYLE 504 KAWNEER STANDARD KEVED RIM CYLINDER SURFACE CLOSER 280 ALUMINUM THRESHOLD GASKETING & SHEEP (PEMCO)

G.C. TO INSTALL METAL ASTRALAG TO MATCH DOOR FINISH ONTO ACTIVE DOOR.

DOOR CLOSER, ARROW LOCK MODEL, IRON SERIES, MEETS (ADA) BARRIER FREE REQUIREMENTS OF 5 LBS. MAXIMUM DOORS. G.C. SHALL INSTALL DOOR CLOSERS ON BOTH DOORS.

IVES FLOOR MOUNTED DOOR STOP, IVES FS456 - SATIN CHROME HARDWARE FINISH. 626-SATIN CHROME PLATED.

**DOOR AND FRAME TYPE:**  
 3'-0" X 7'-0" EXTERIOR SOLID CORE METAL DOORS WITH 2" HOLLOW METAL HELPER DOOR FRAME. THE DOOR FRAME ASSEMBLY WILL BE FACTORY PRIMED 16 GAUGE METAL. (DOOR FINISH TO MATCH EXISTING DOORS)

**HARDWARE TYPE:**  
 MATCH EXISTING EXTERIOR DOOR HARDWARE

DOOR CLOSER, ARROW LOCK MODEL, IRON SERIES, MEETS (ADA) BARRIER FREE REQUIREMENTS OF 5 LBS. MAXIMUM DOORS.

IVES DOOR STOP, #436

HARDWARE FINISH: MATCH EXISTING EXTERIOR DOOR SYSTEM.

**DOOR AND FRAME TYPE:**  
 INDICATES 3'-0" X 7'-0" X 1 3/4" KAWNEER FLUSHLINE ENTRANCES. ALUMINUM FRAMED VISION LITES. TYPE AVL-4, 6' X 32" LOCK SIDE PLACEMENT 1" FROM TOP OF DOOR AND JAMB. PLAIN ALUM. SHEET EXTERIOR AND INTERIOR. COLOR AND FINISH TO MATCH STOREFRONT FRAMING.

**HARDWARE TYPE:**  
 PAIR AND HALF BUTT HINGE, KAWNEER STANDARD KAWNEER STANDARD EXIT DEVICE, DUR-O-MATIC / PALCON 1790 EXTERIOR FULL STYLE 504 KAWNEER STANDARD KEVED RIM CYLINDER SURFACE CLOSER 280 ALUMINUM THRESHOLD GASKETING & SHEEP (PEMCO)

DOOR CLOSER, ARROW LOCK MODEL, IRON SERIES, MEETS (ADA) BARRIER FREE REQUIREMENTS OF 5 LBS. MAXIMUM DOORS. G.C. SHALL INSTALL DOOR CLOSERS ON BOTH DOORS.

IVES FLOOR MOUNTED DOOR STOP, IVES FS456 - SATIN CHROME HARDWARE FINISH. 626-SATIN CHROME PLATED.

**DOOR SCHEDULE NOTES:**

1. ALL HARDWARE FINISH SHALL BE: SATIN CHROME PLATED #626
2. G.C. SHALL PROVIDE ALL MISCELLANEOUS DOOR HARDWARE REQUIRED FOR PROPER OPERATION OR TO MEET CODE REQUIREMENTS
3. ALL DOORS SHALL BE UNDERCUT AS REQUIRED TO ALLOW FOR PROPER CLEARANCE FOR FLOOR FINISH.
4. G.C. SHALL PROVIDE TO ARCHITECT HARDWARE SPECIFICATION AND SHOP DRAWINGS FOR REVIEW PRIOR TO ORDERING OR FABRICATING.
5. OWNER SHALL BE RESPONSIBLE FOR MASTER KEYING DOOR HARDWARE / LOCKSETS.
6. G.C. SHALL INSTALL DOOR SILENCERS AT ALL DOOR FRAMES.
7. PER FEDERAL REGISTER, RULES AND REGULATIONS SECTION 4.13.4 DOOR HARDWARE, HANDLES, PULLS, LOCKS, AND OTHER OPERATING DEVICES ON ACCESSIBLE DOORS SHALL HAVE A SHAPE THAT IS EASY TO GRASP WITH ONE HAND AND DOES NOT REQUIRE TIGHT GRASPING, TIGHT PINCHING, OR TWISTING OF THE WRIST TO OPERATE. LEVER OPERATED MECHANISM PUSH (TIE) MECHANISMS, AND U-SHAPED HANDLES ARE ACCEPTABLE DESIGNS. WHEN SLIDING DOORS ARE FULLY OPEN, OPERATING HARDWARE SHALL BE EXPOSED AND USABLE FROM BOTH SIDES. HARDWARE USED ON ACCESSIBLE DOOR PASSAGE SHALL BE MOUNTED NO HIGHER THAN 48" ABOVE FINISHED FLOOR.
8. PER FEDERAL REGISTER RULES AND REGULATIONS SECTION 4.13.0 DOOR CLOSERS IF THE DOOR HAS A CLOSER THEN THE SHUTTER PERIOD OF THE CLOSER SHALL BE ADJUSTED SO THAT FROM AN OPEN POSITION OF 10 DEGREES, THE DOOR WILL TAKE AT LEAST 3 SECONDS TO MOVE TO A POINT 3" FROM THE LATCH, MEASURED TO THE LEADING EDGE OF THE DOOR.
9. PER FEDERAL REGISTER, RULES AND REGULATIONS SECTION 4.13.1 DOOR OPENING FORCE: THE MAXIMUM FORCE FOR PUSHING OR PULLING OPEN A DOOR SHALL BE AS FOLLOWS:
  - (1) INTERIOR DOORS SHALL HAVE THE MINIMUM OPEN FORCE ALLOWABLE BY THE APPROPRIATE ADMINISTRATIVE AUTHORITY.
  - (2) OTHER DOORS:
    - (a) EXTERIOR HINGED DOORS: (RESERVED)
    - (b) INTERIOR HINGED DOORS: 5 LBS (22.2N)
    - (c) SLIDING OR FOLDING DOORS: 5 LBS (22.2N)
 THESE FORCES DO NOT APPLY TO THE FORCE REQUIRED TO RETRAG LATCH BOLTS OR DISengage OTHER DEVICES THAT MAY HOLD THE DOOR IN A CLOSED POSITION.
10. G.C. SHALL SUBMIT TO ARCHITECT (3) SAMPLES OF DOOR STAINFINISH FOR REVIEW PRIOR TO DOOR FABRICATION/ORDERING AND FINAL FINISH APPLICATION.
11. G.C. SHALL SUPPLY MASTER KEY TO TENANT TO OPERATE ALL DOORS.

**INDICATES CARD KEY DEVICES TO ACTIVATE ELECTRIC STRIKES.**  
 CARD READER SYSTEM WILL BE PROVIDED AND INSTALLED BY TENANT VENDOR. G.C. SHALL INSTALL 3/4" DIA. CONDUIT UP TO 6" ABOVE FINISHED CEILING AND 3/8" DIA. IN PARTITION. G.C. TO COORDINATE WITH CARD READER SECURITY SYSTEM VENDOR FOR LOCK REQUIREMENTS. CARD READER SYSTEM SHALL BE WIRED BACK TO BUILDING FIRE ALARM SYSTEM TO ALLOW FOR FAIL SAFE OPERATION. NO EXCEPTIONS.


NO.	DATE	DESCRIPTION
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SCALE:	DATE:	PROJECT NO.:
AS NOTED	05/17/21	21-000-00
DRAWN BY:	CHECKED BY:	APPROVED BY:
	A.M.	
DRAWING TITLE:		
CONSTRUCTION PLAN		


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ISSUE FOR PLANNING BOARD REVIEW	07/27/21
ISSUE FOR PLANNING BOARD REVIEW	09/27/21

REGISTERED ARCHITECT  
 STATE OF NEW YORK  
 02819


SCALE: AS NOTED DATE: 05/17/21 PROJECT NO: 21-000-00  
 DRAWN BY: CHECKED BY: APPROVED BY:  
 DRAWING TITLE:  
**ELEVATIONS**

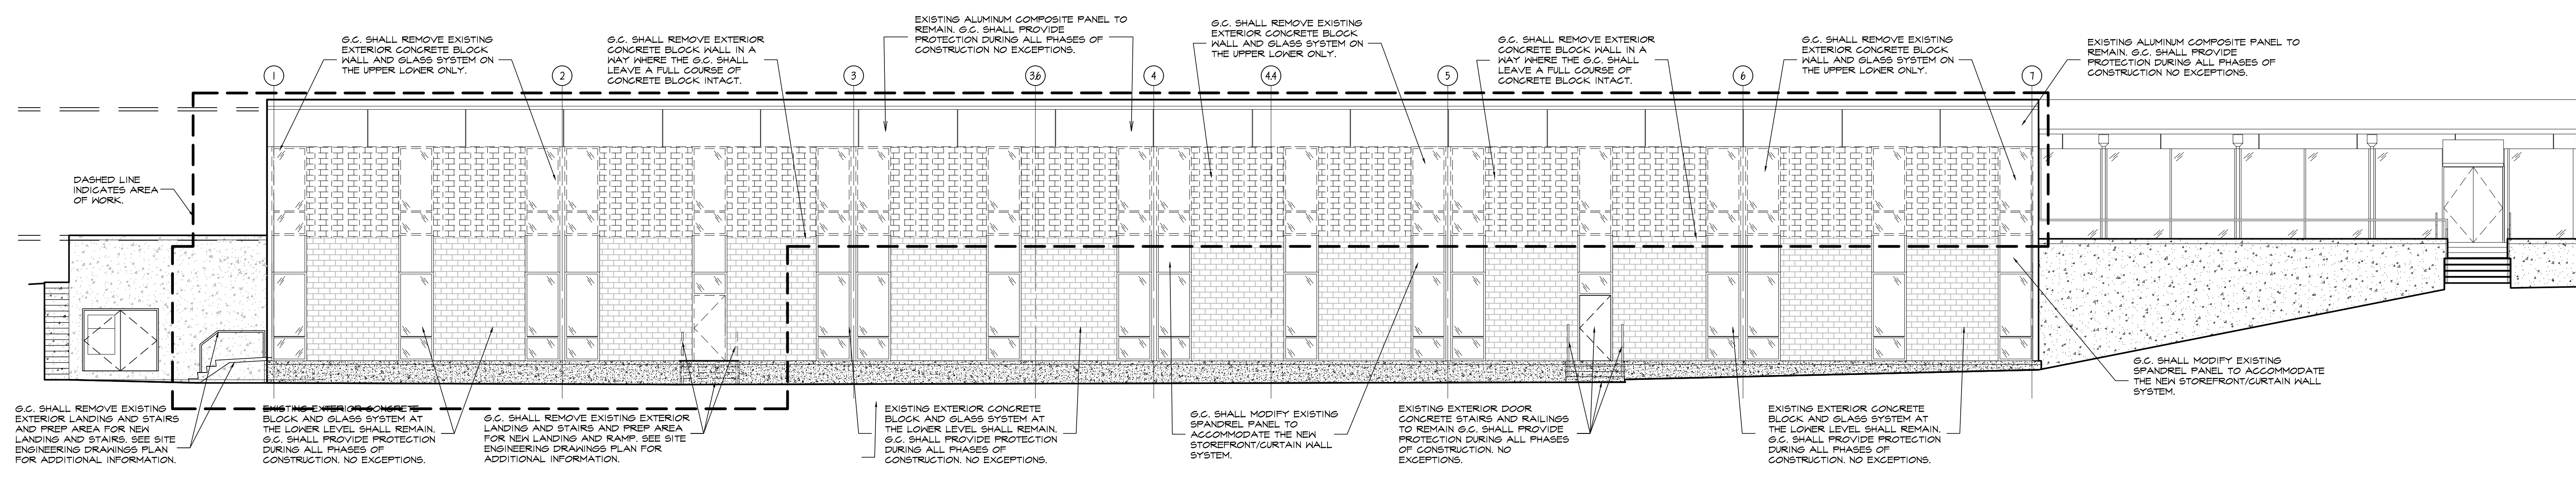

**A** PROPOSED DEMOLITION OF REAR ELEVATION  
 SCALE: 1/8"=1'-0"

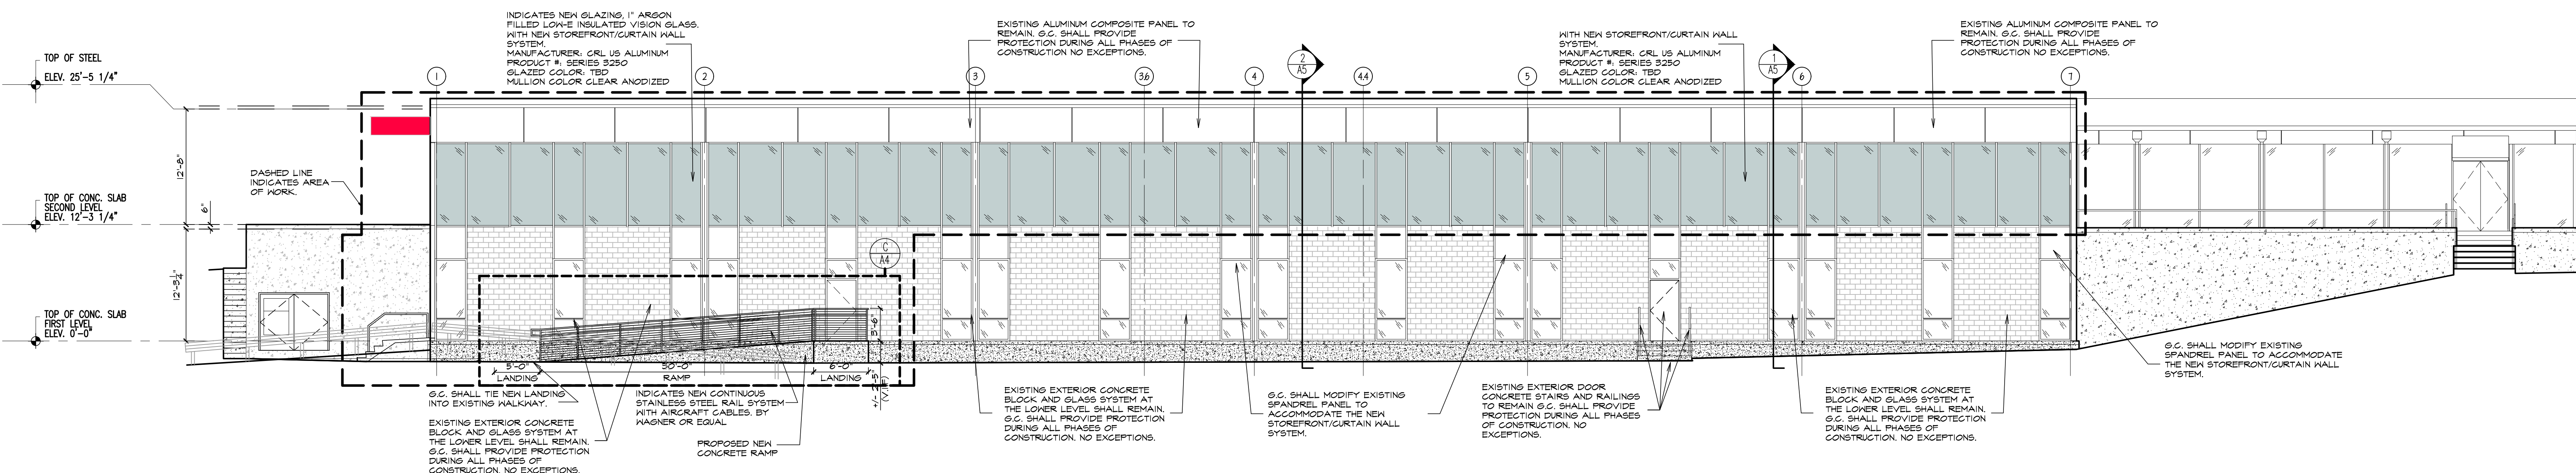


**B** PROPOSED NEW REAR ELEVATION  
 SCALE: 1/8"=1'-0"

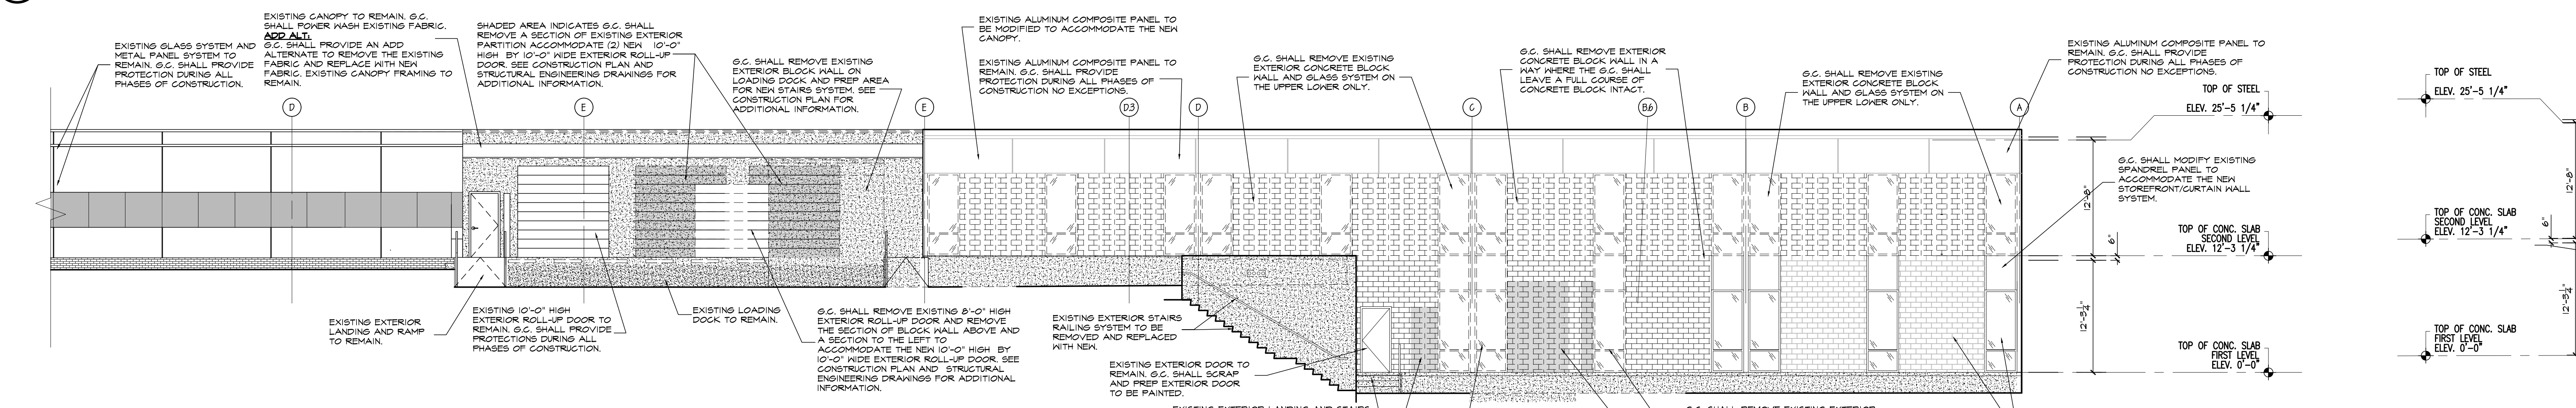


**E** PROPOSED DEMOLITION OF SIDE ELEVATION  
 SCALE: 1/8"=1'-0"

**C** PROPOSED DEMOLITION OF SIDE ELEVATION  
 SCALE: 1/8"=1'-0"

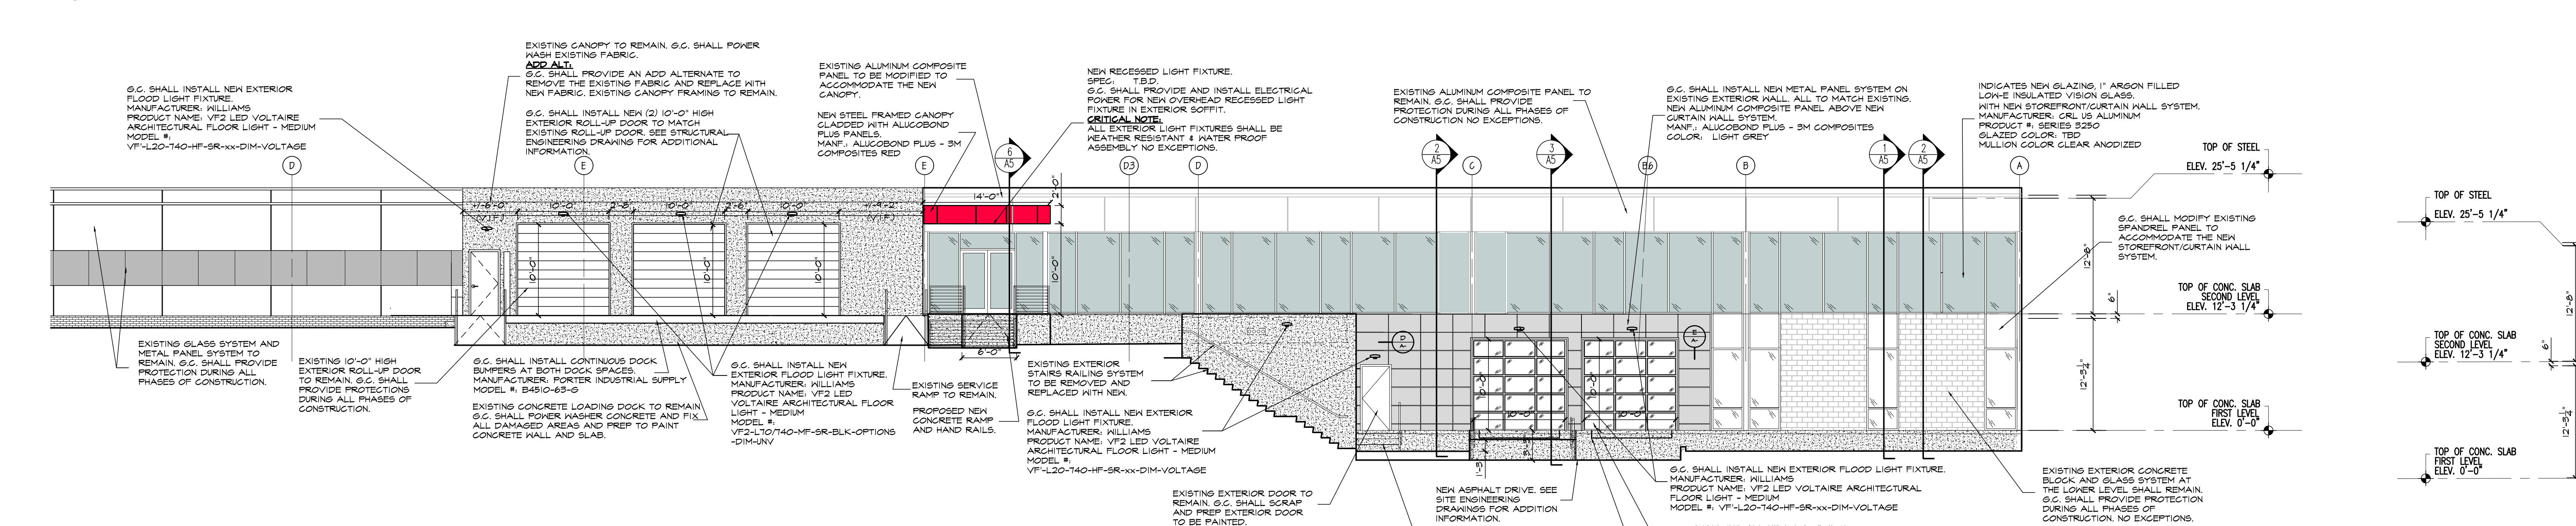


**D** PROPOSED PARTIAL SIDE ELEVATION  
 SCALE: 1/8"=1'-0"


**F** PROPOSED PARTIAL SIDE ELEVATION  
 SCALE: 1/8"=1'-0"

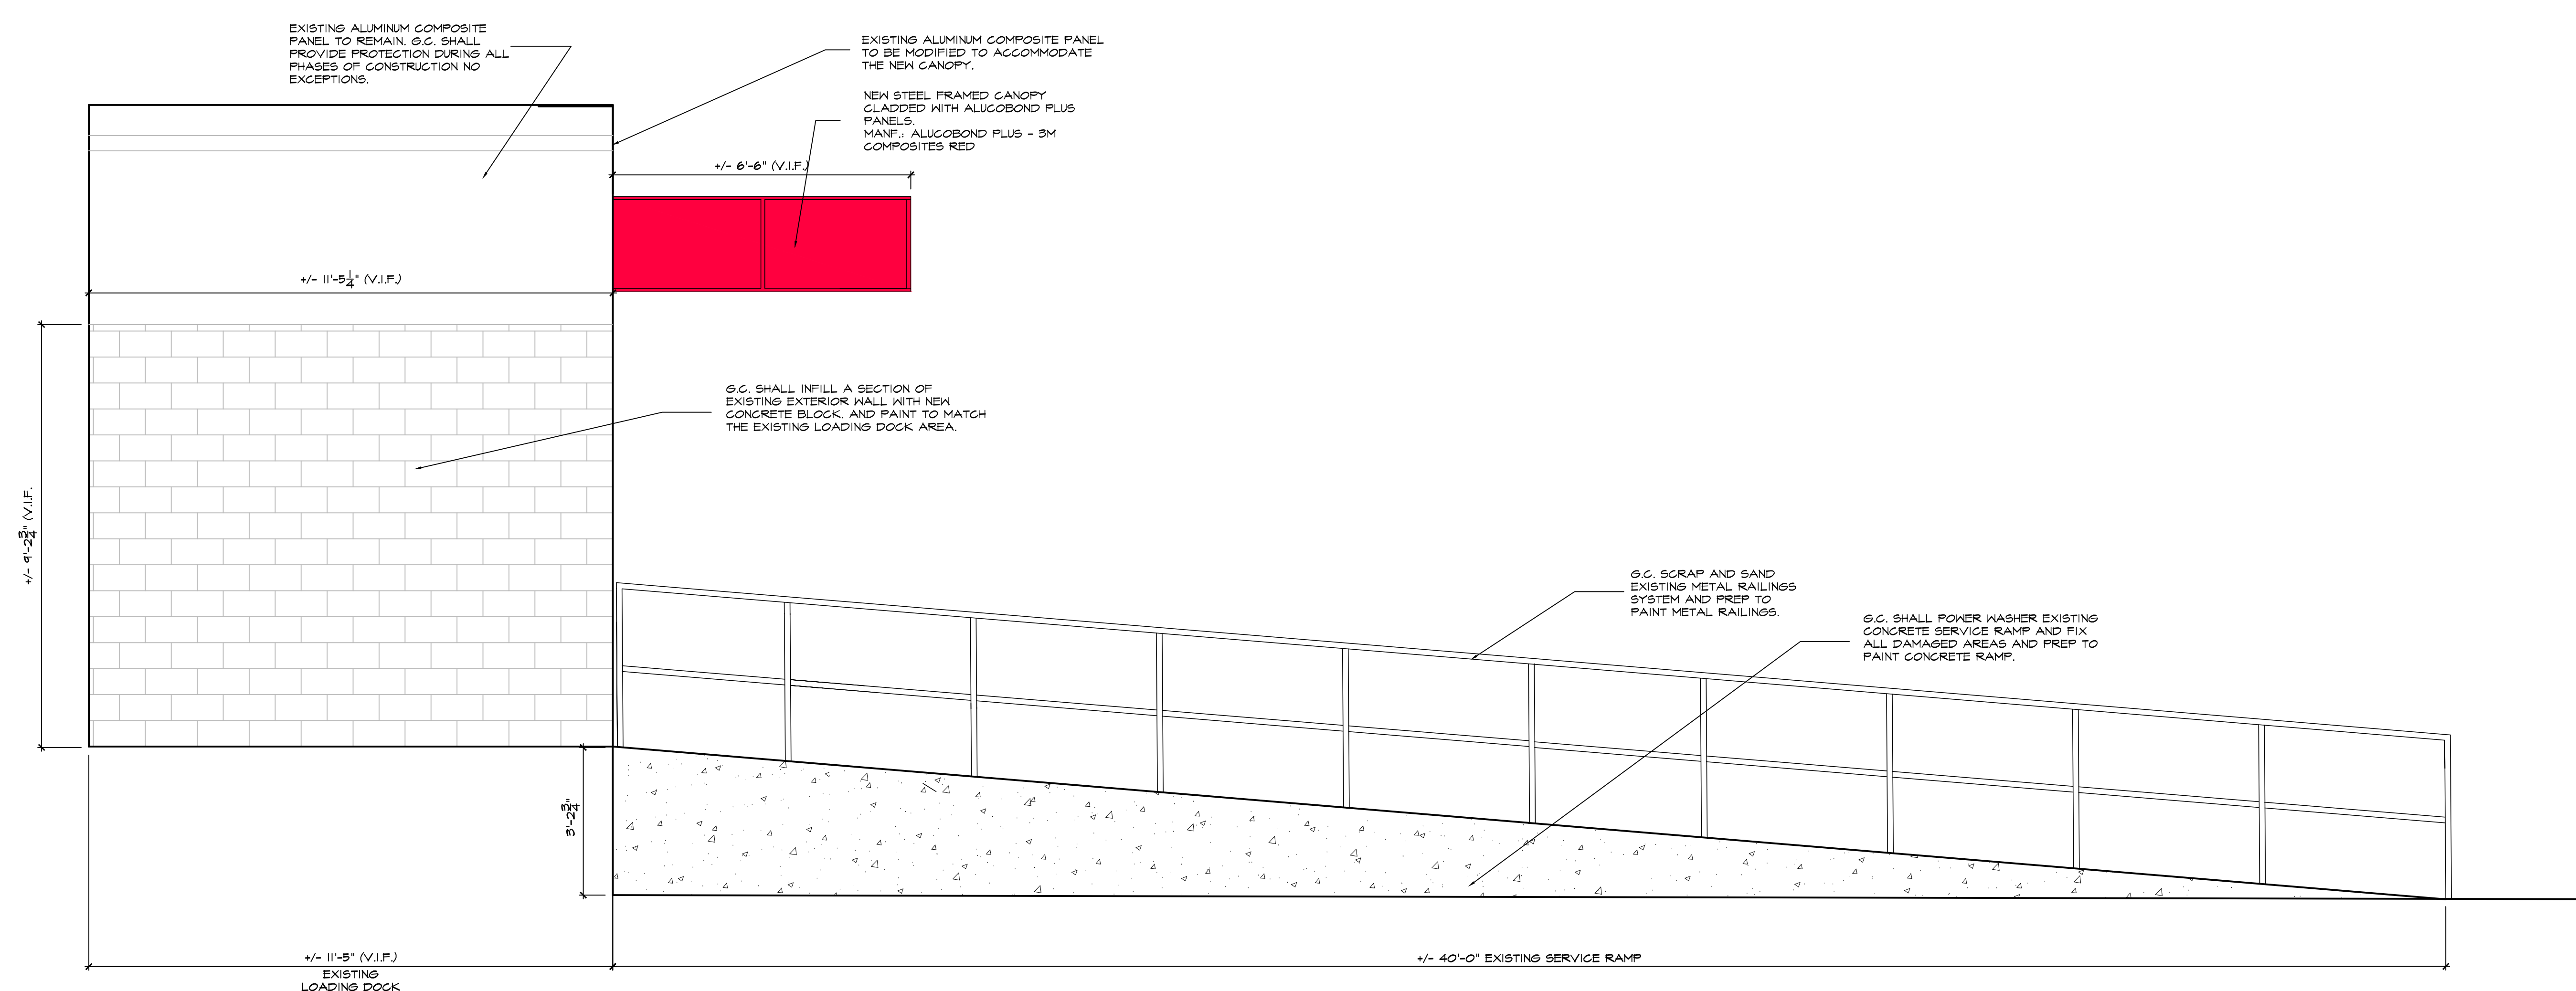

**A** PROPOSED BUILDING ENCLOSURE AND EXISTING SERVICE RAMP  
SCALE: 1/2"=1'-0"

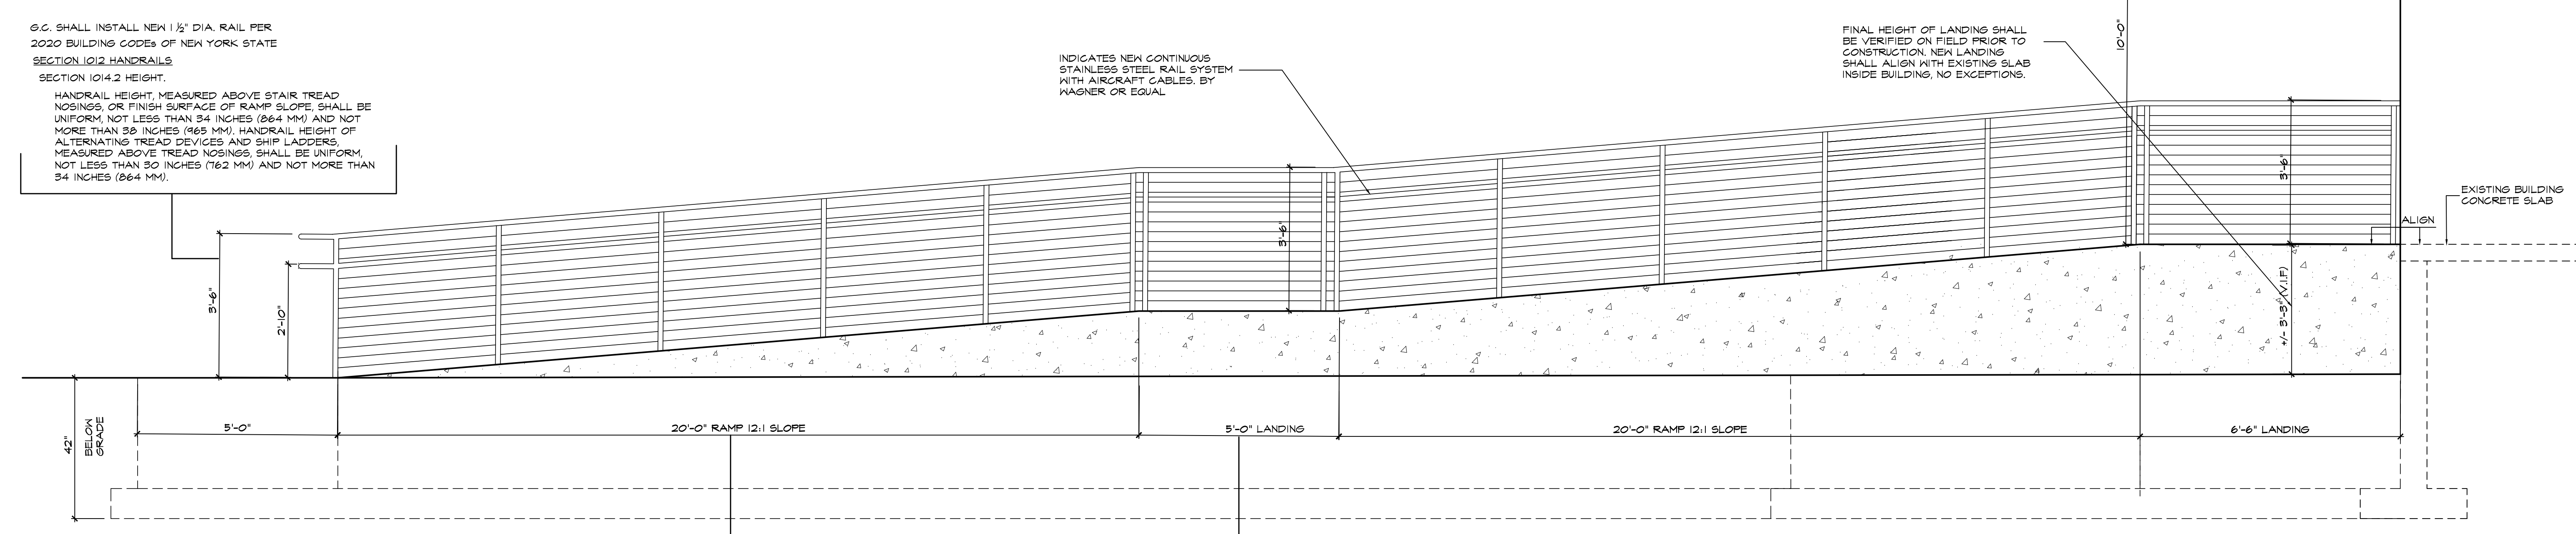

**B** PROPOSED ADA RAMP AND CANOPY  
SCALE: 1/2"=1'-0"

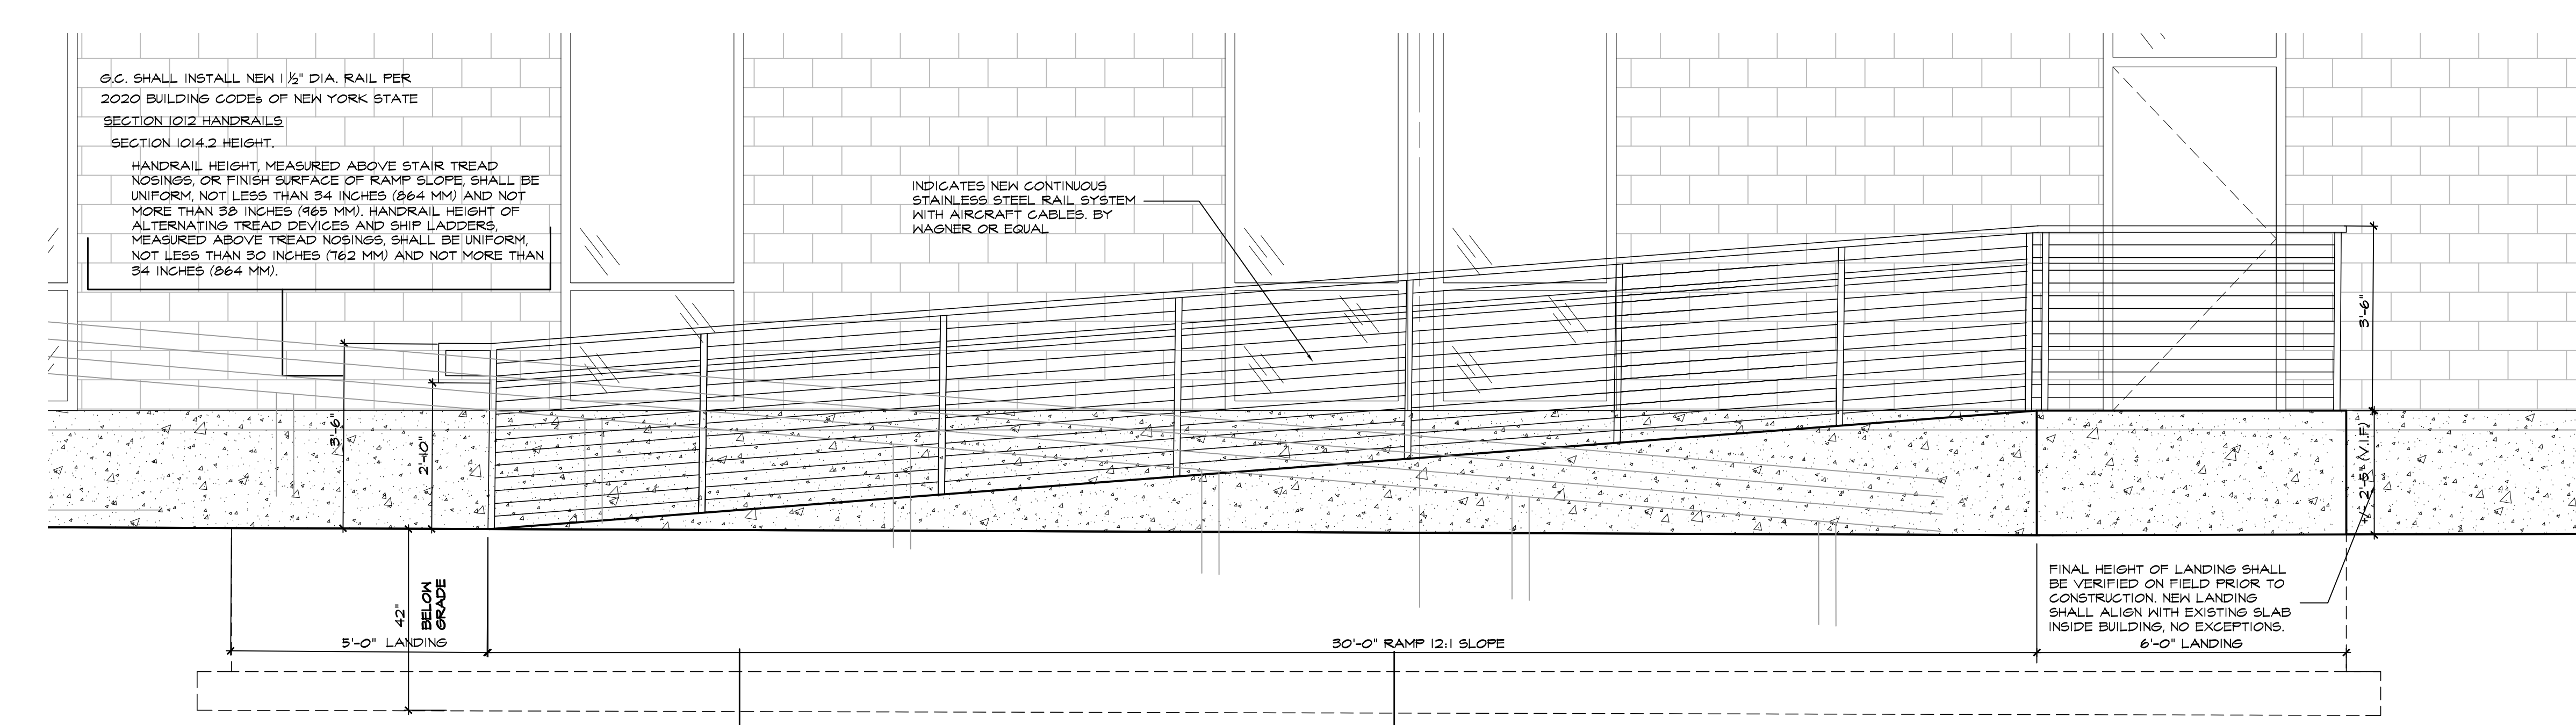

**C** PROPOSED ADA RAMP AND CANOPY  
SCALE: 1/2"=1'-0"


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DATE	BY	PROJECT NO.
05/17/21		21-000-00


REGISTERED ARCHITECT  
STATE OF NEW YORK  
02819

SCALE: AS NOTED  
DATE: 05/17/21  
DRAWN BY: A.M.  
CHECKED BY:  
APPROVED BY:  
DRAWING TITLE:  
**WALL SECTIONS**


PROPOSED EXTERIOR BUILDING RENOVATIONS  
2651 STRANG BOULEVARD  
YORKTOWN HEIGHTS, NEW YORK 10598  
GROUND FLOOR  
ZONE DISTRICT: OB / SECTION: 26.19 / BLOCK: 1 / LOT: 2

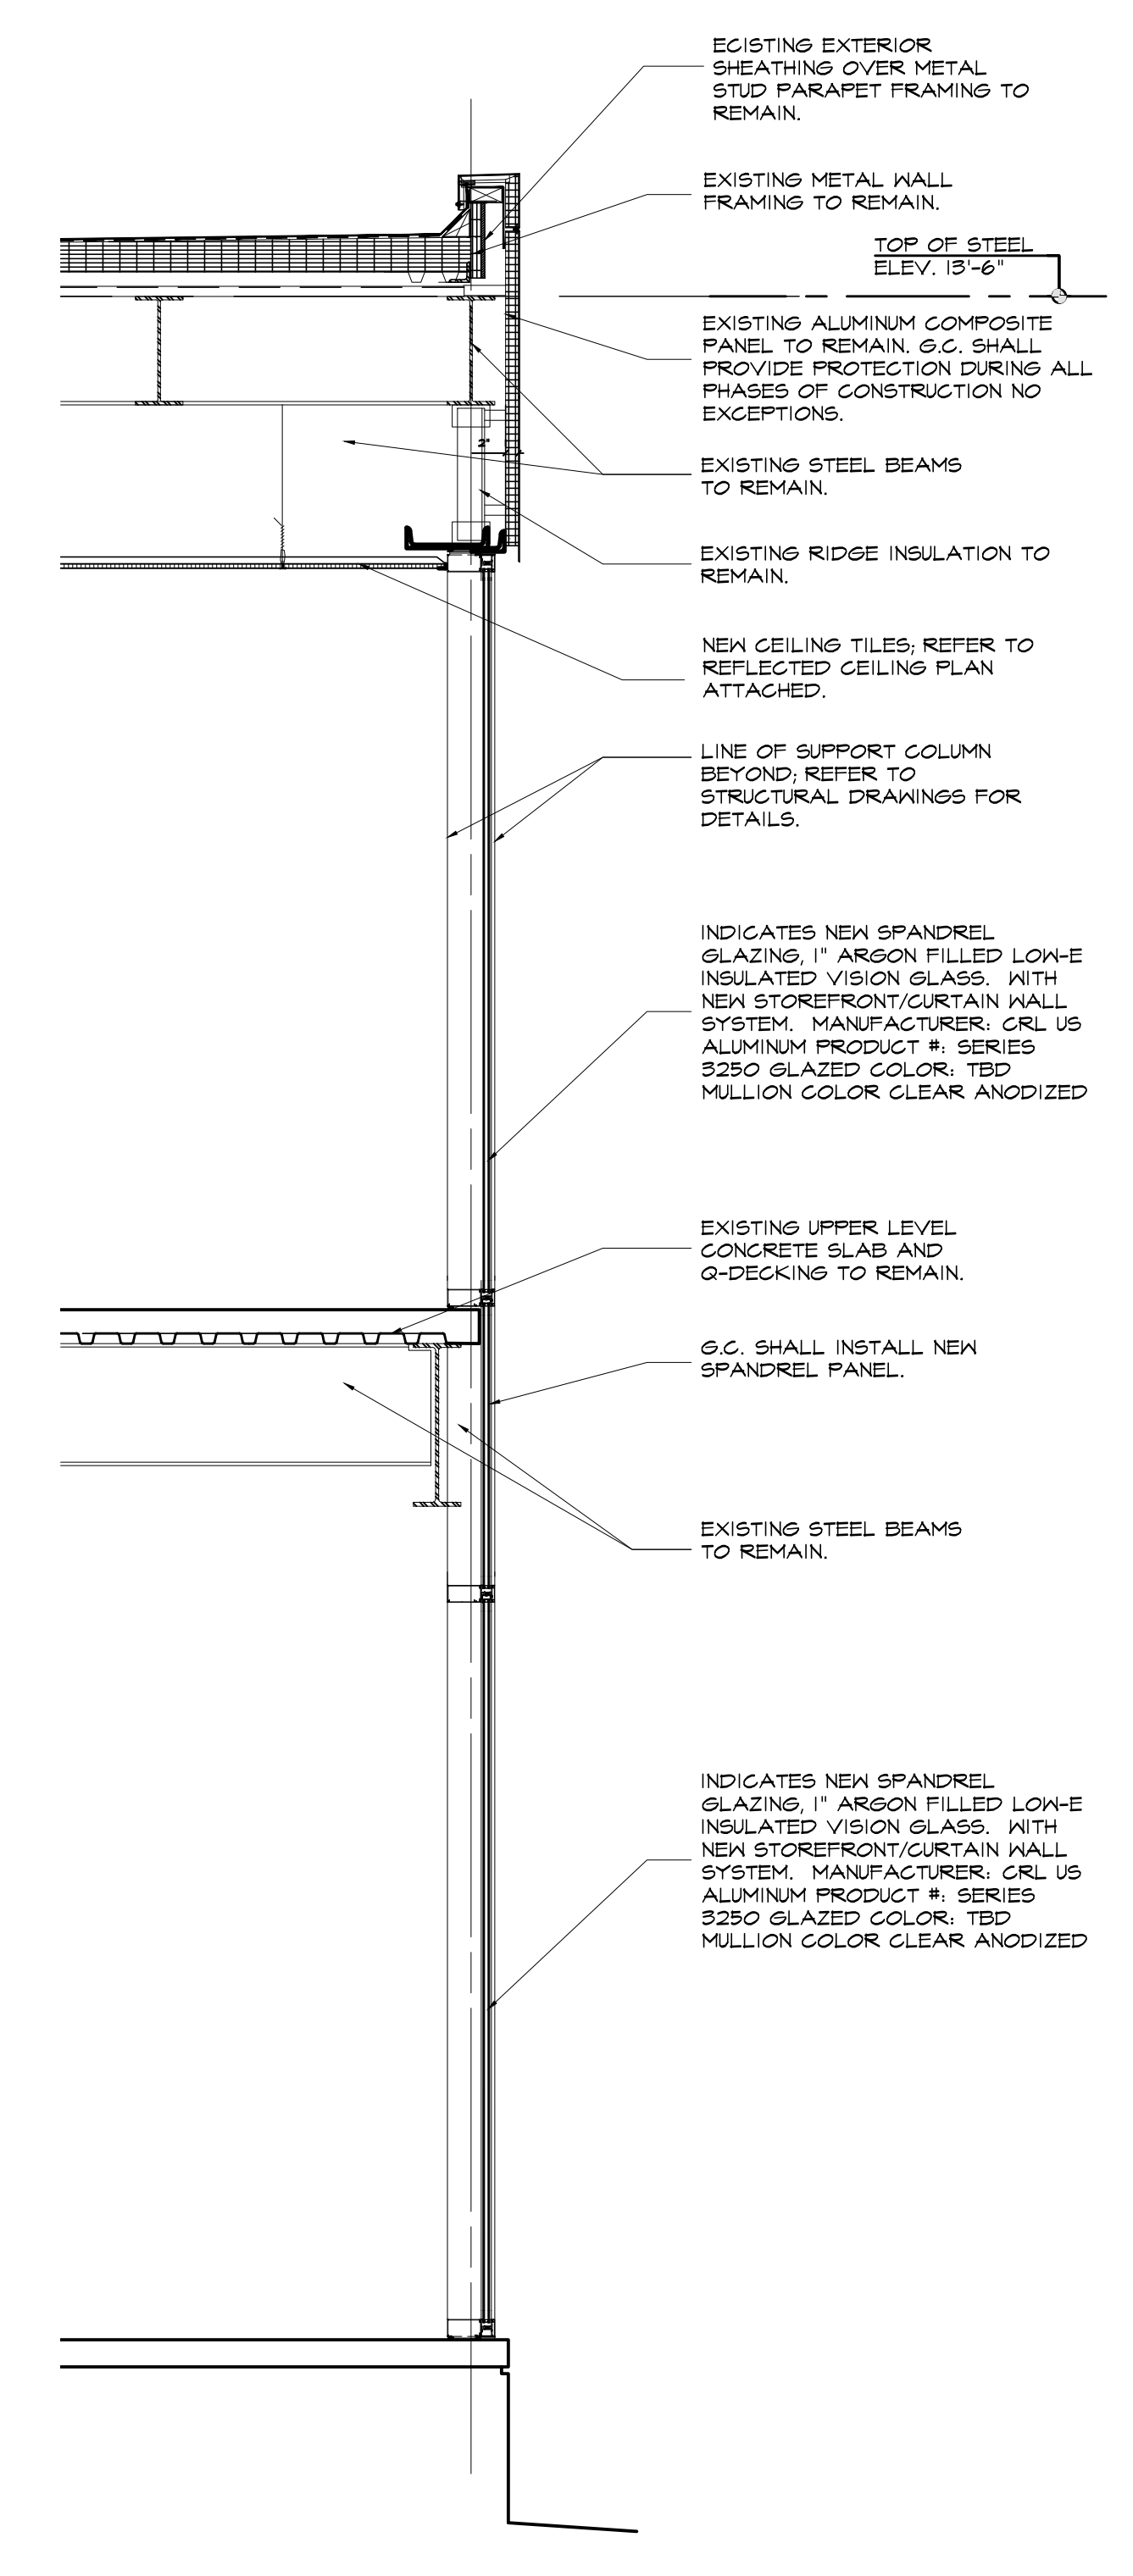


1 WALL SECTION  
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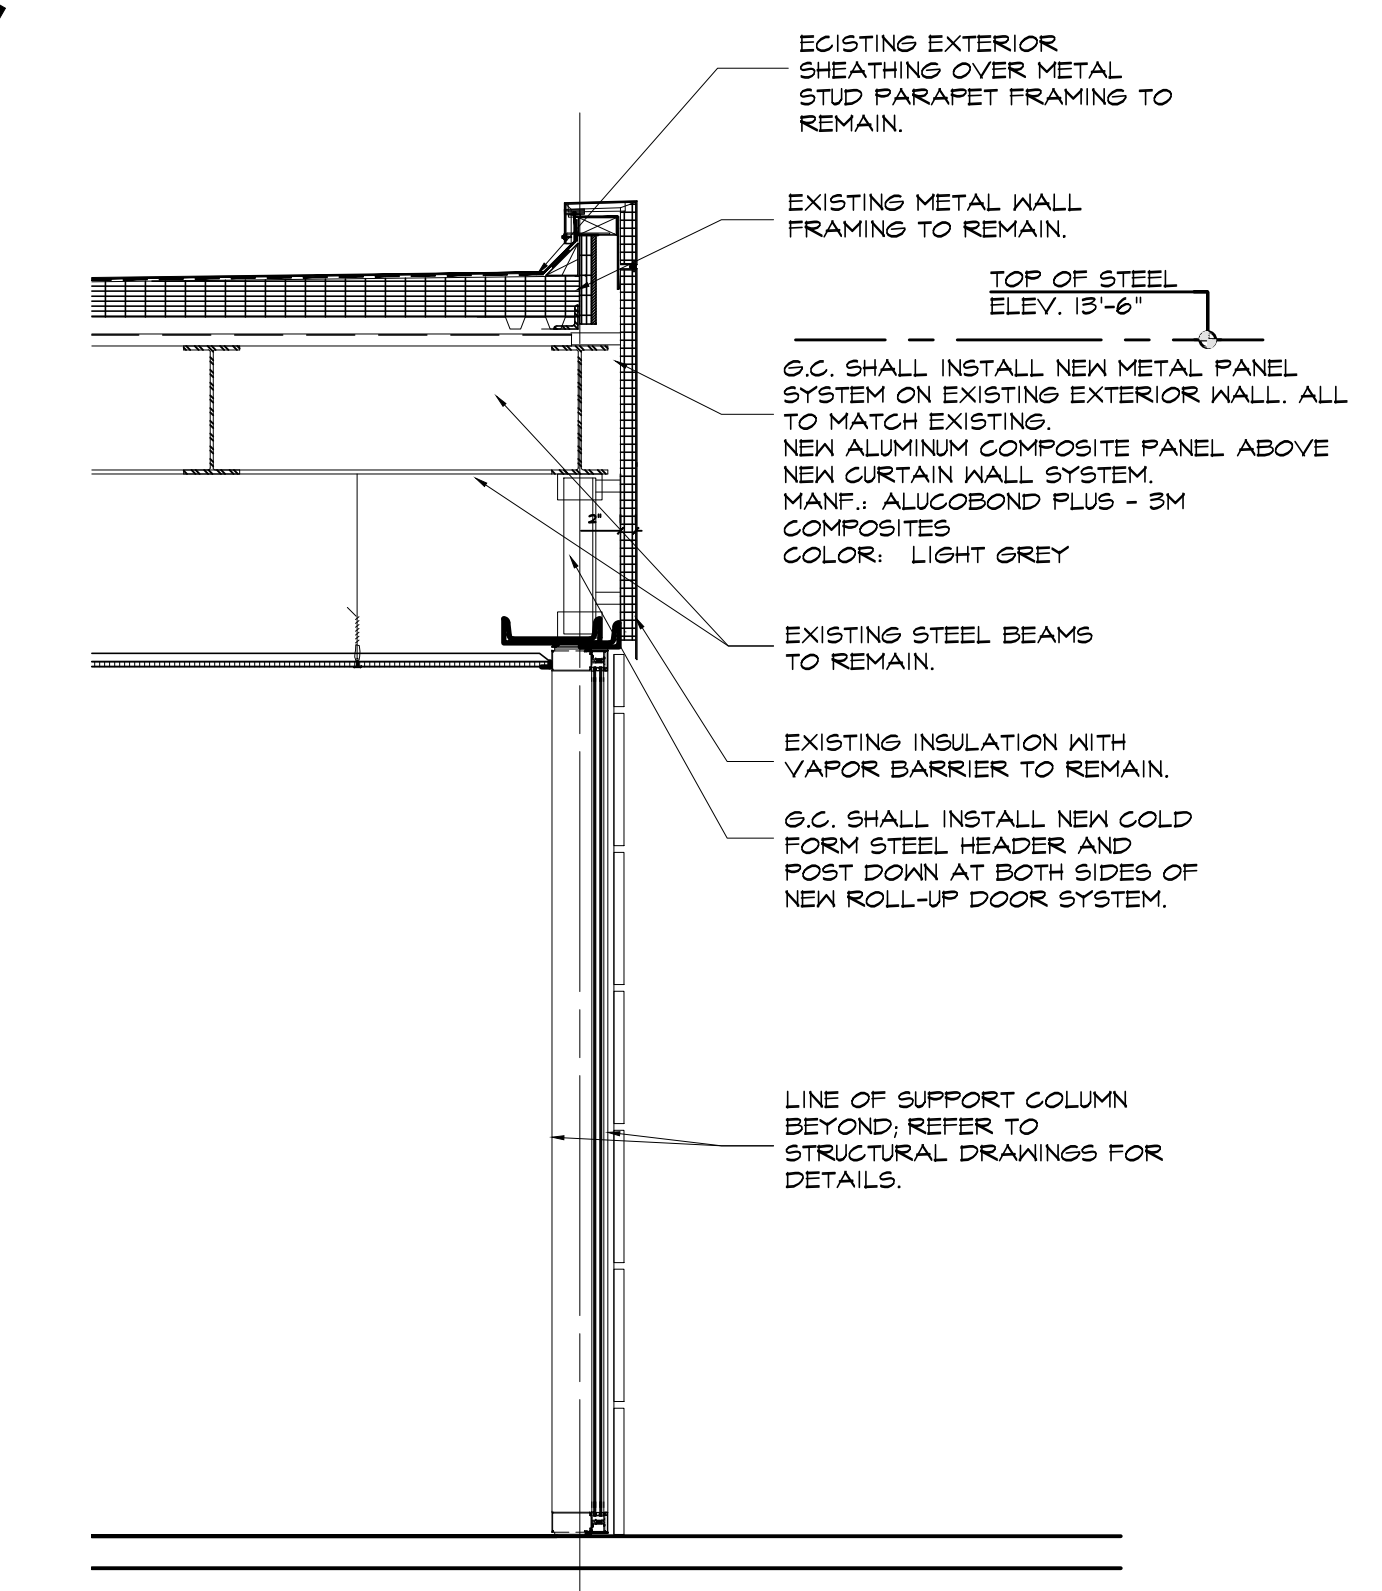
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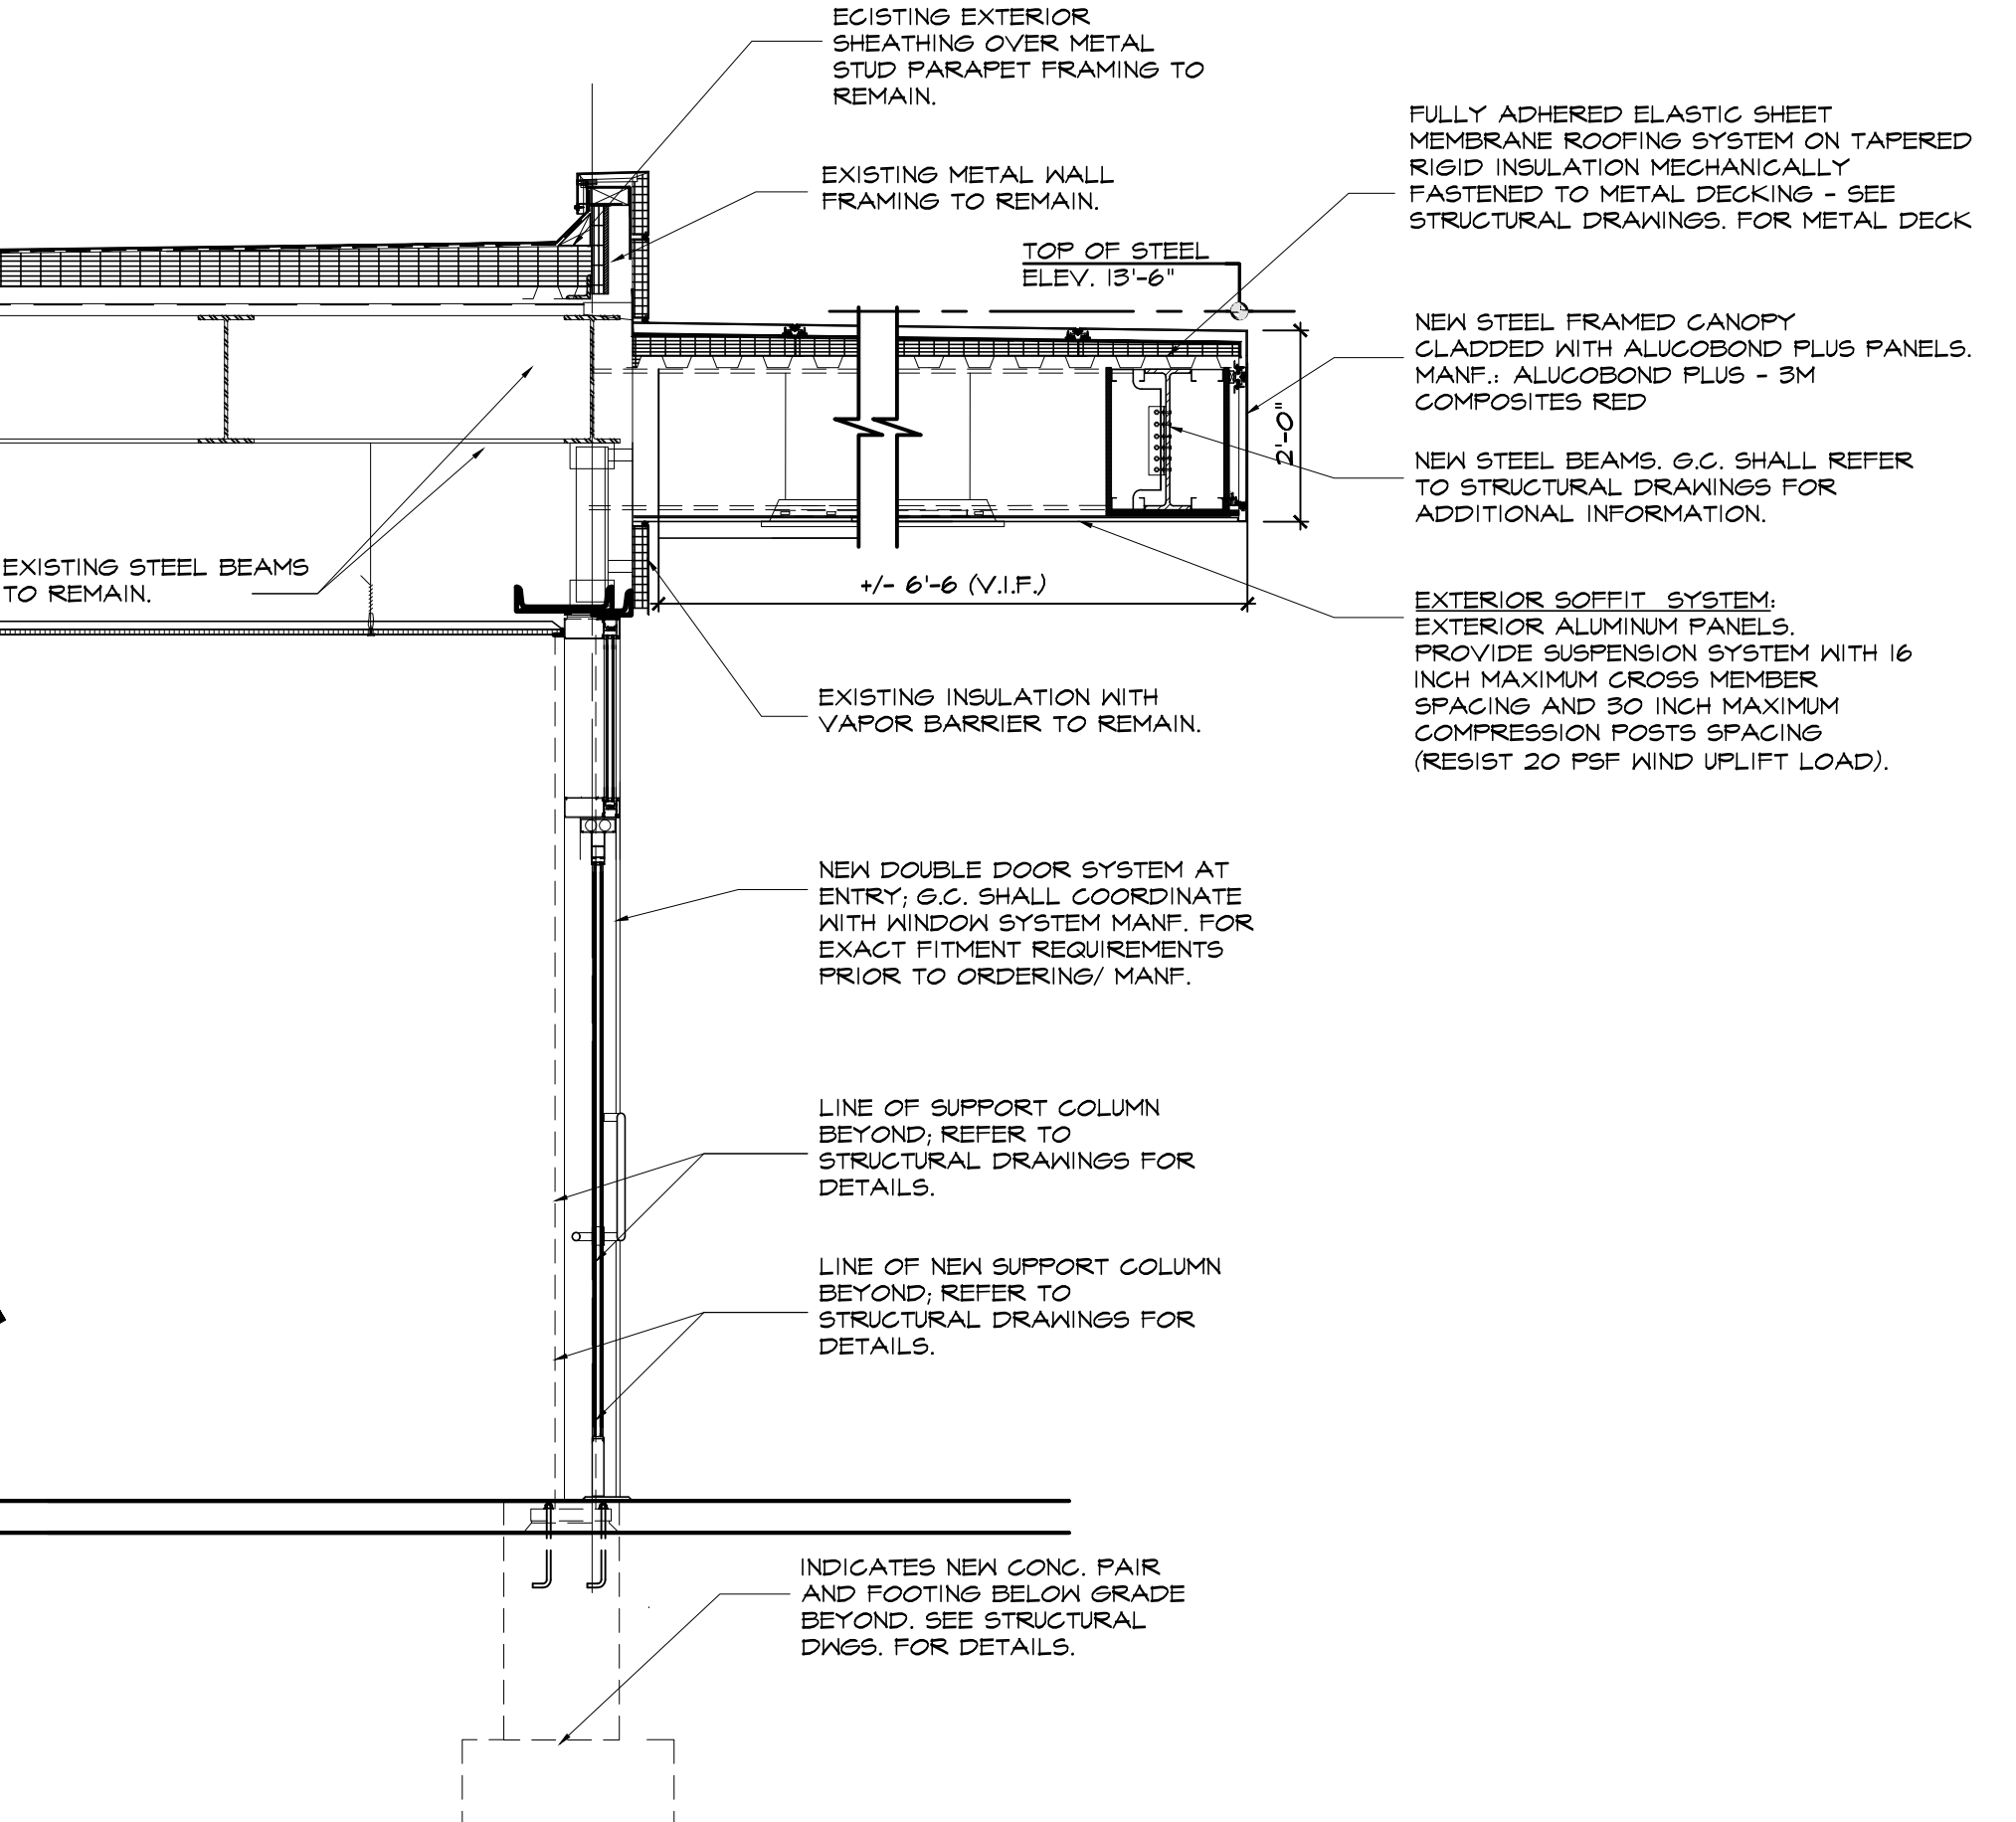
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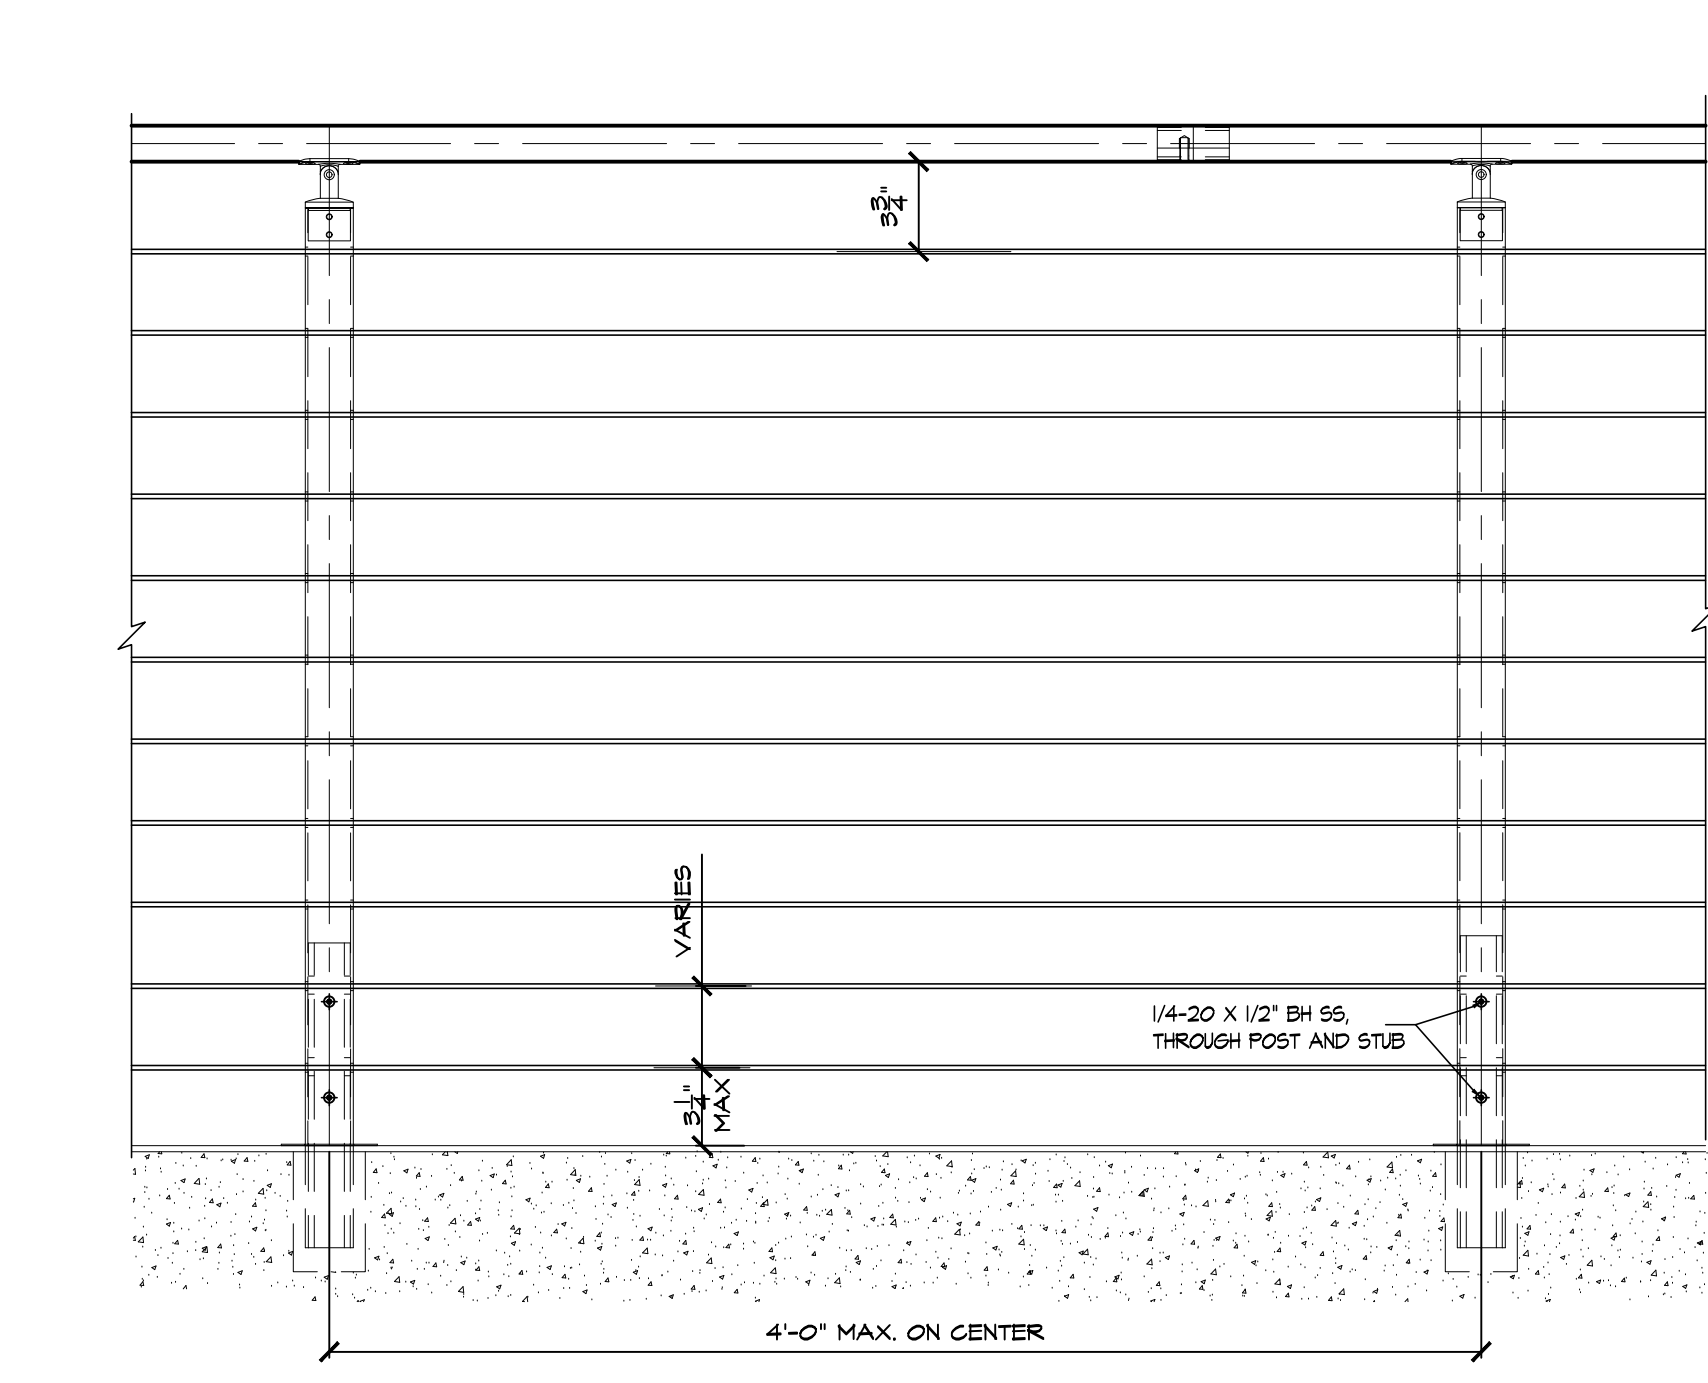
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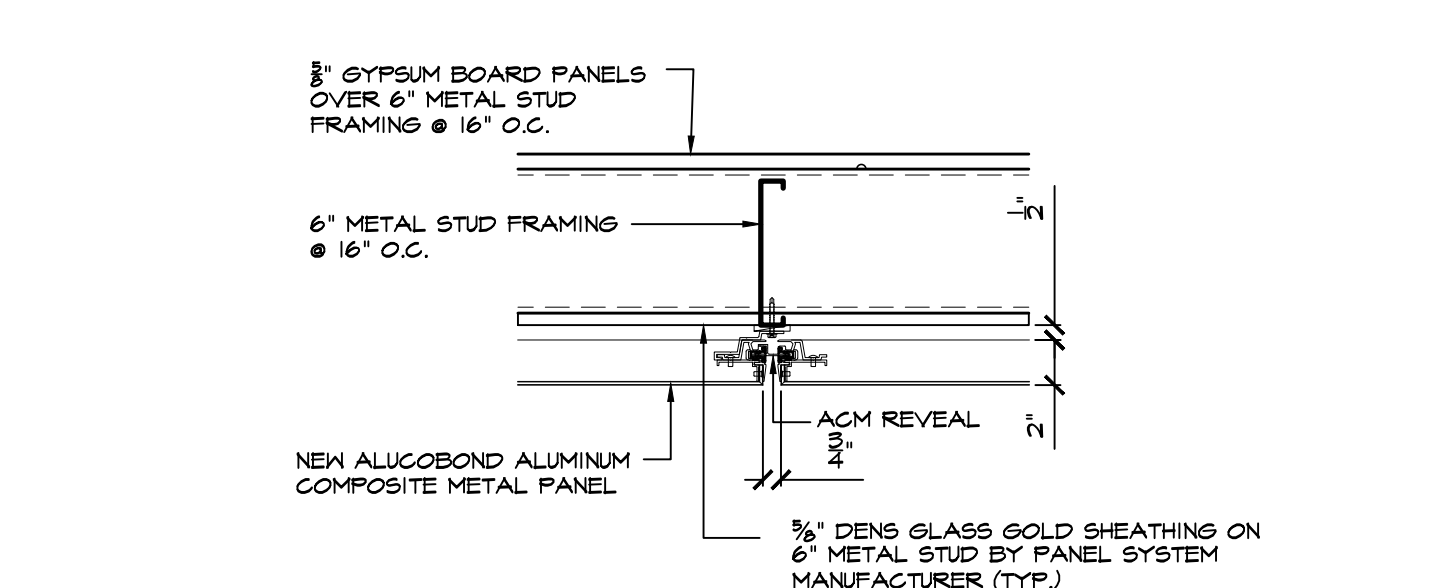
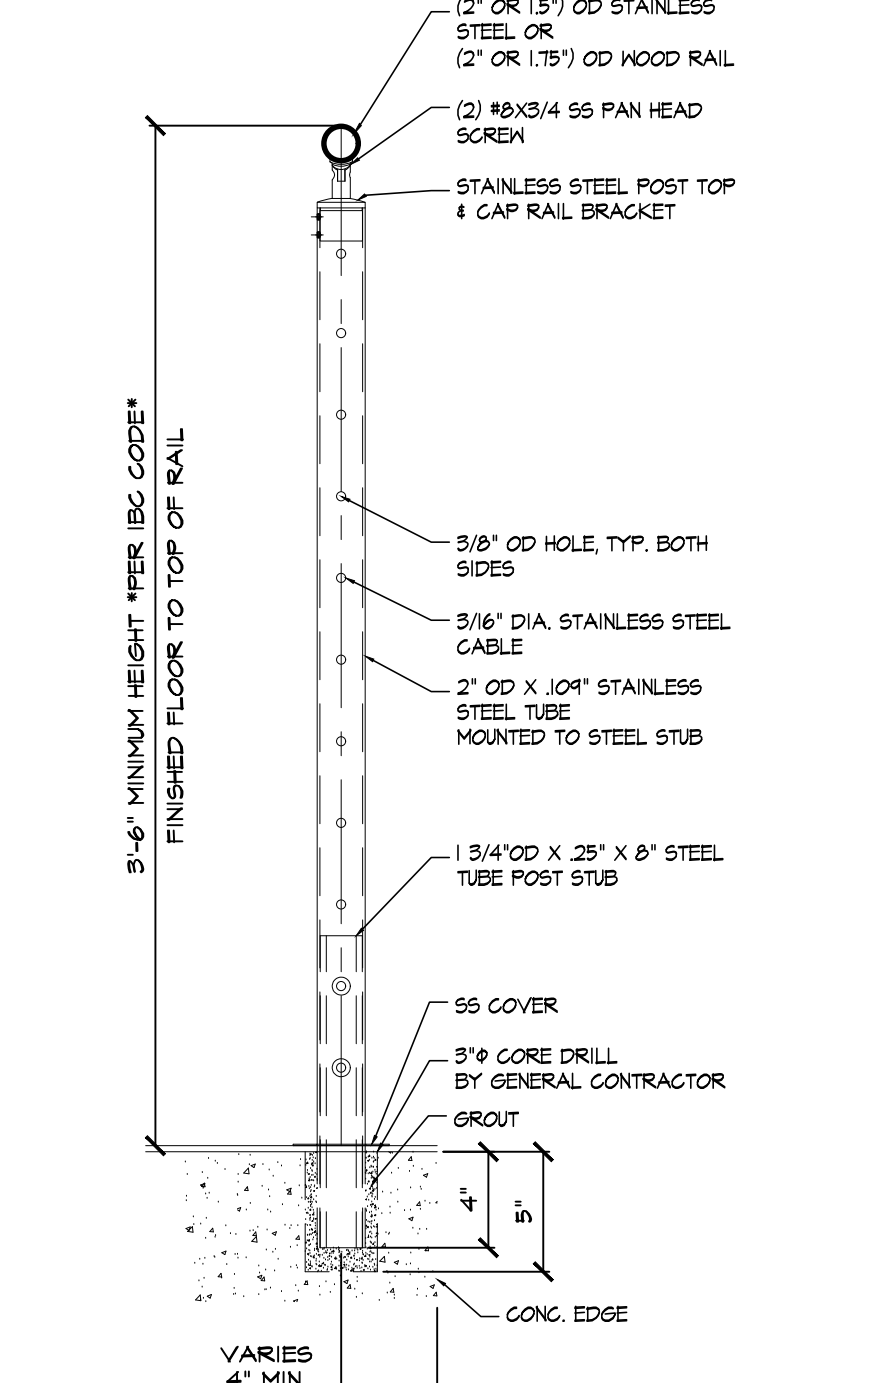
5 WALL SECTION  
SCALE: 1/2" = 1'-0"

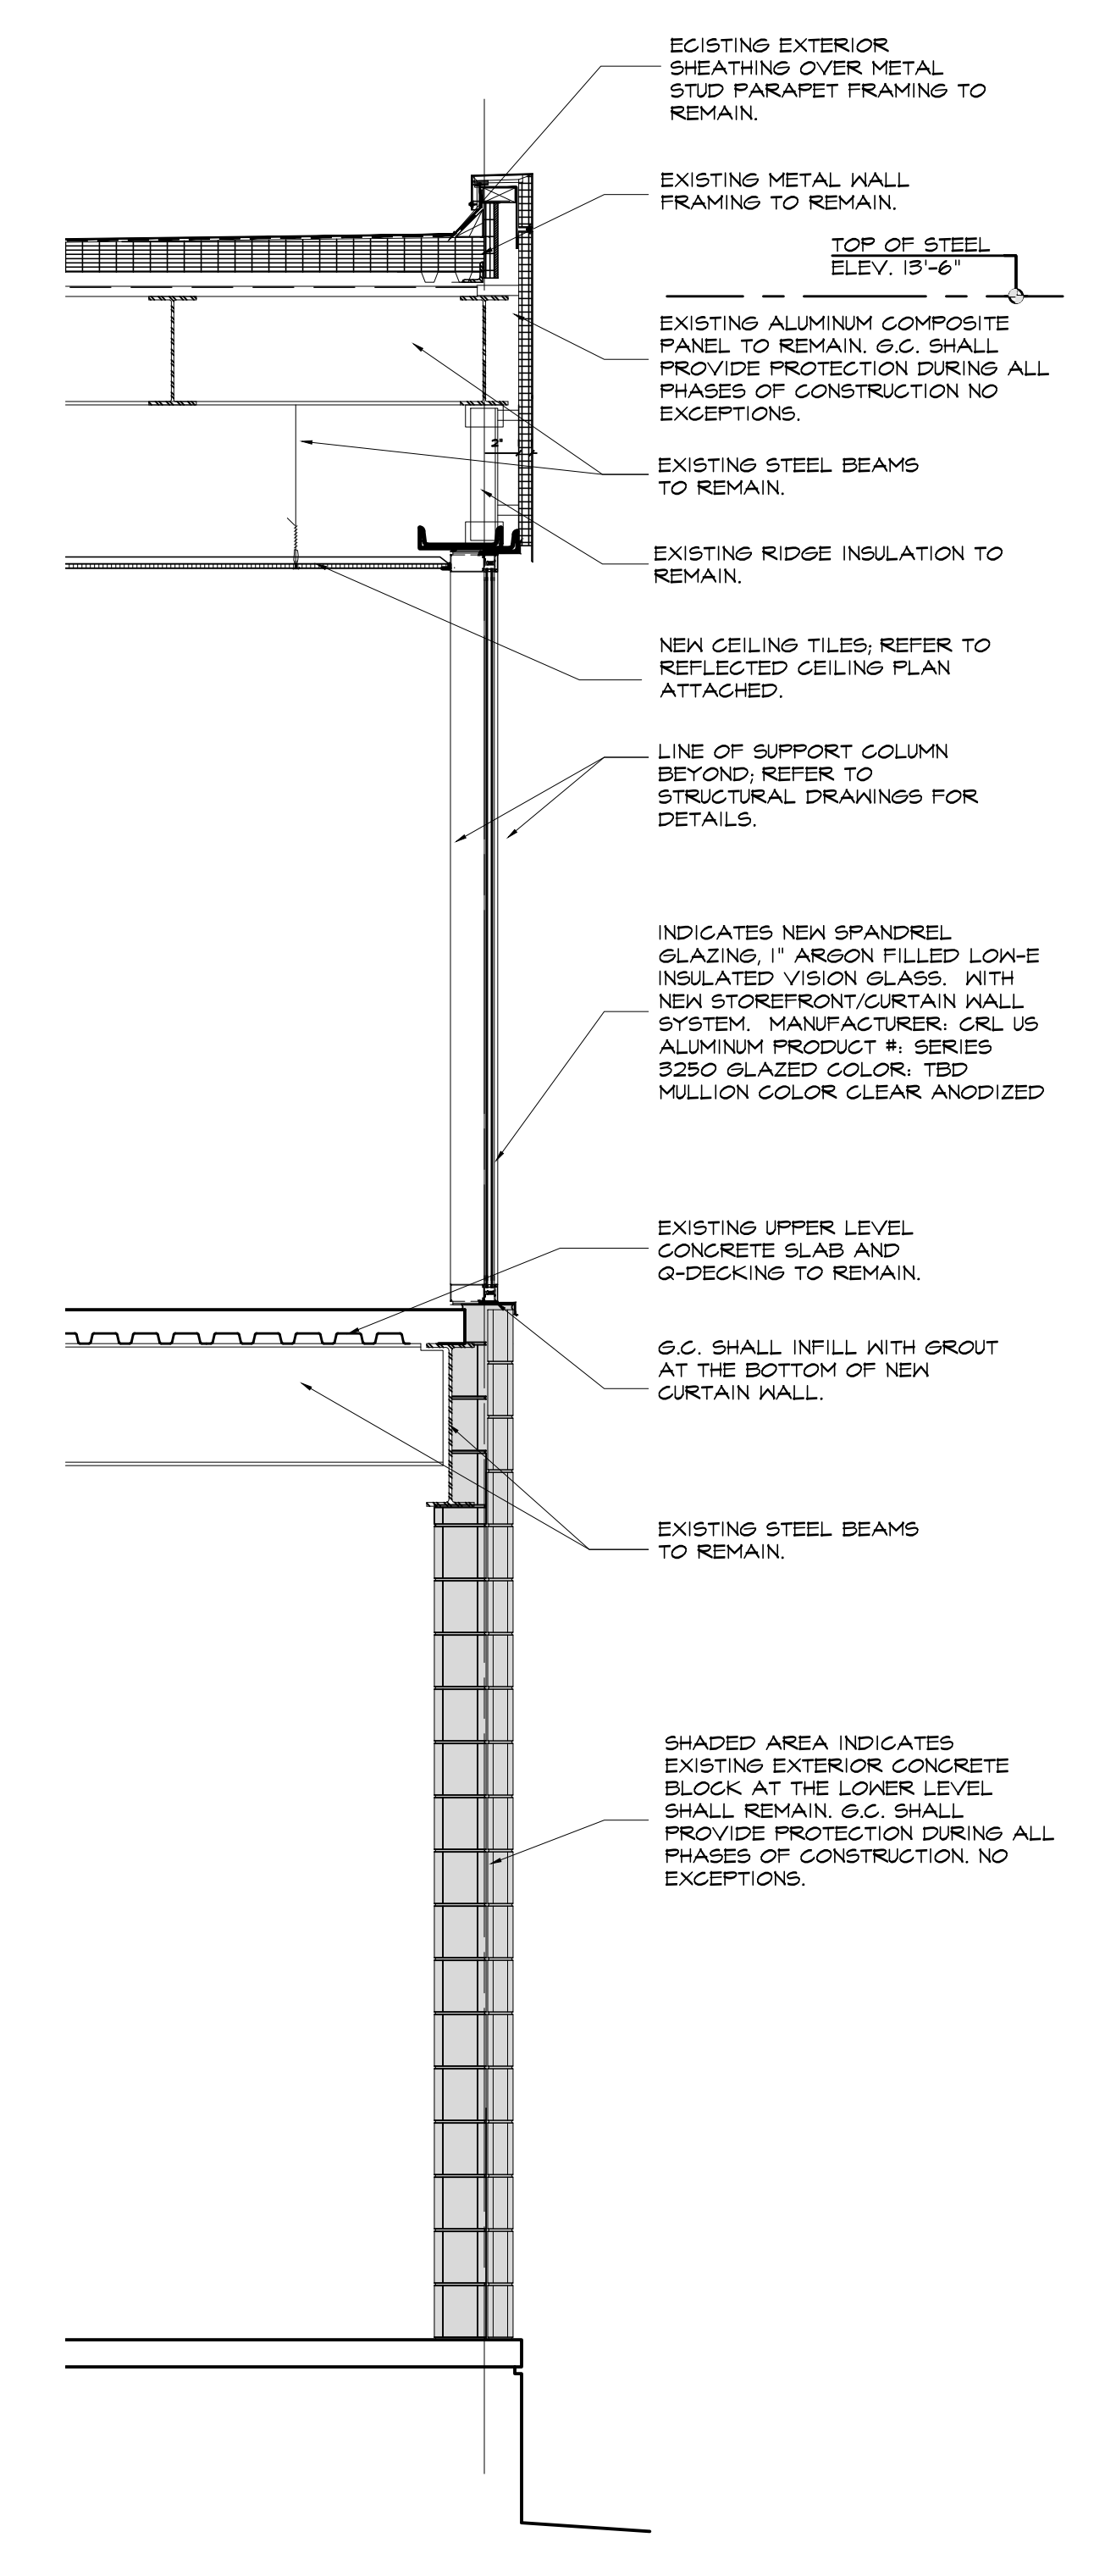

6 WALL SECTION  
SCALE: 1/2" = 1'-0"

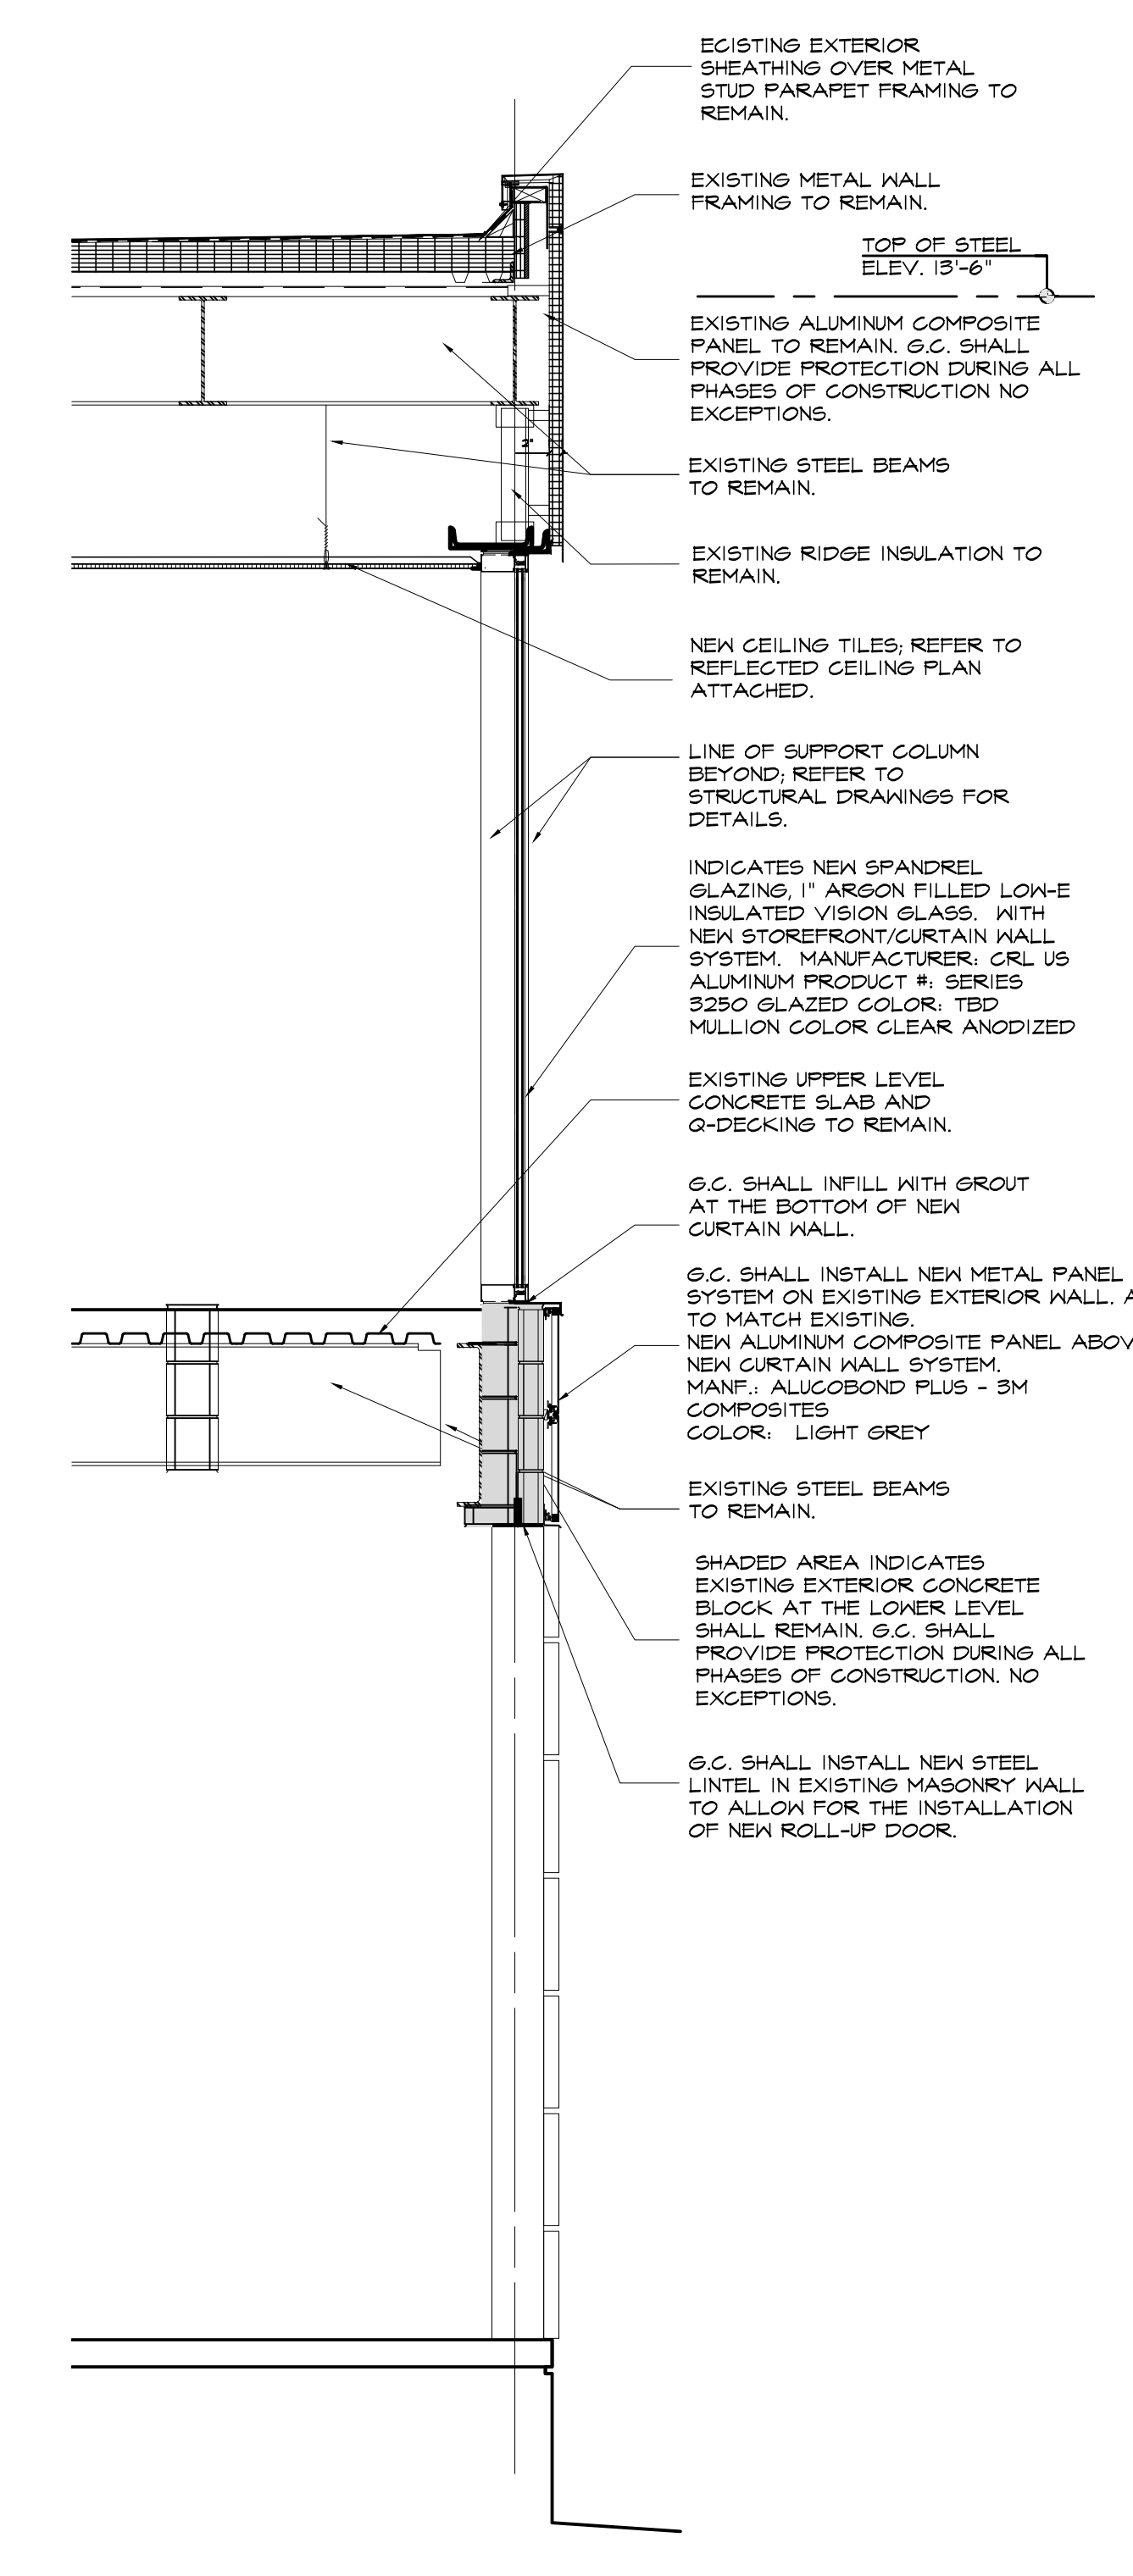


A ELEVATION @ STAIR/ RAMP RAIL - TYP  
SCALE: 1/2" = 1'-0"

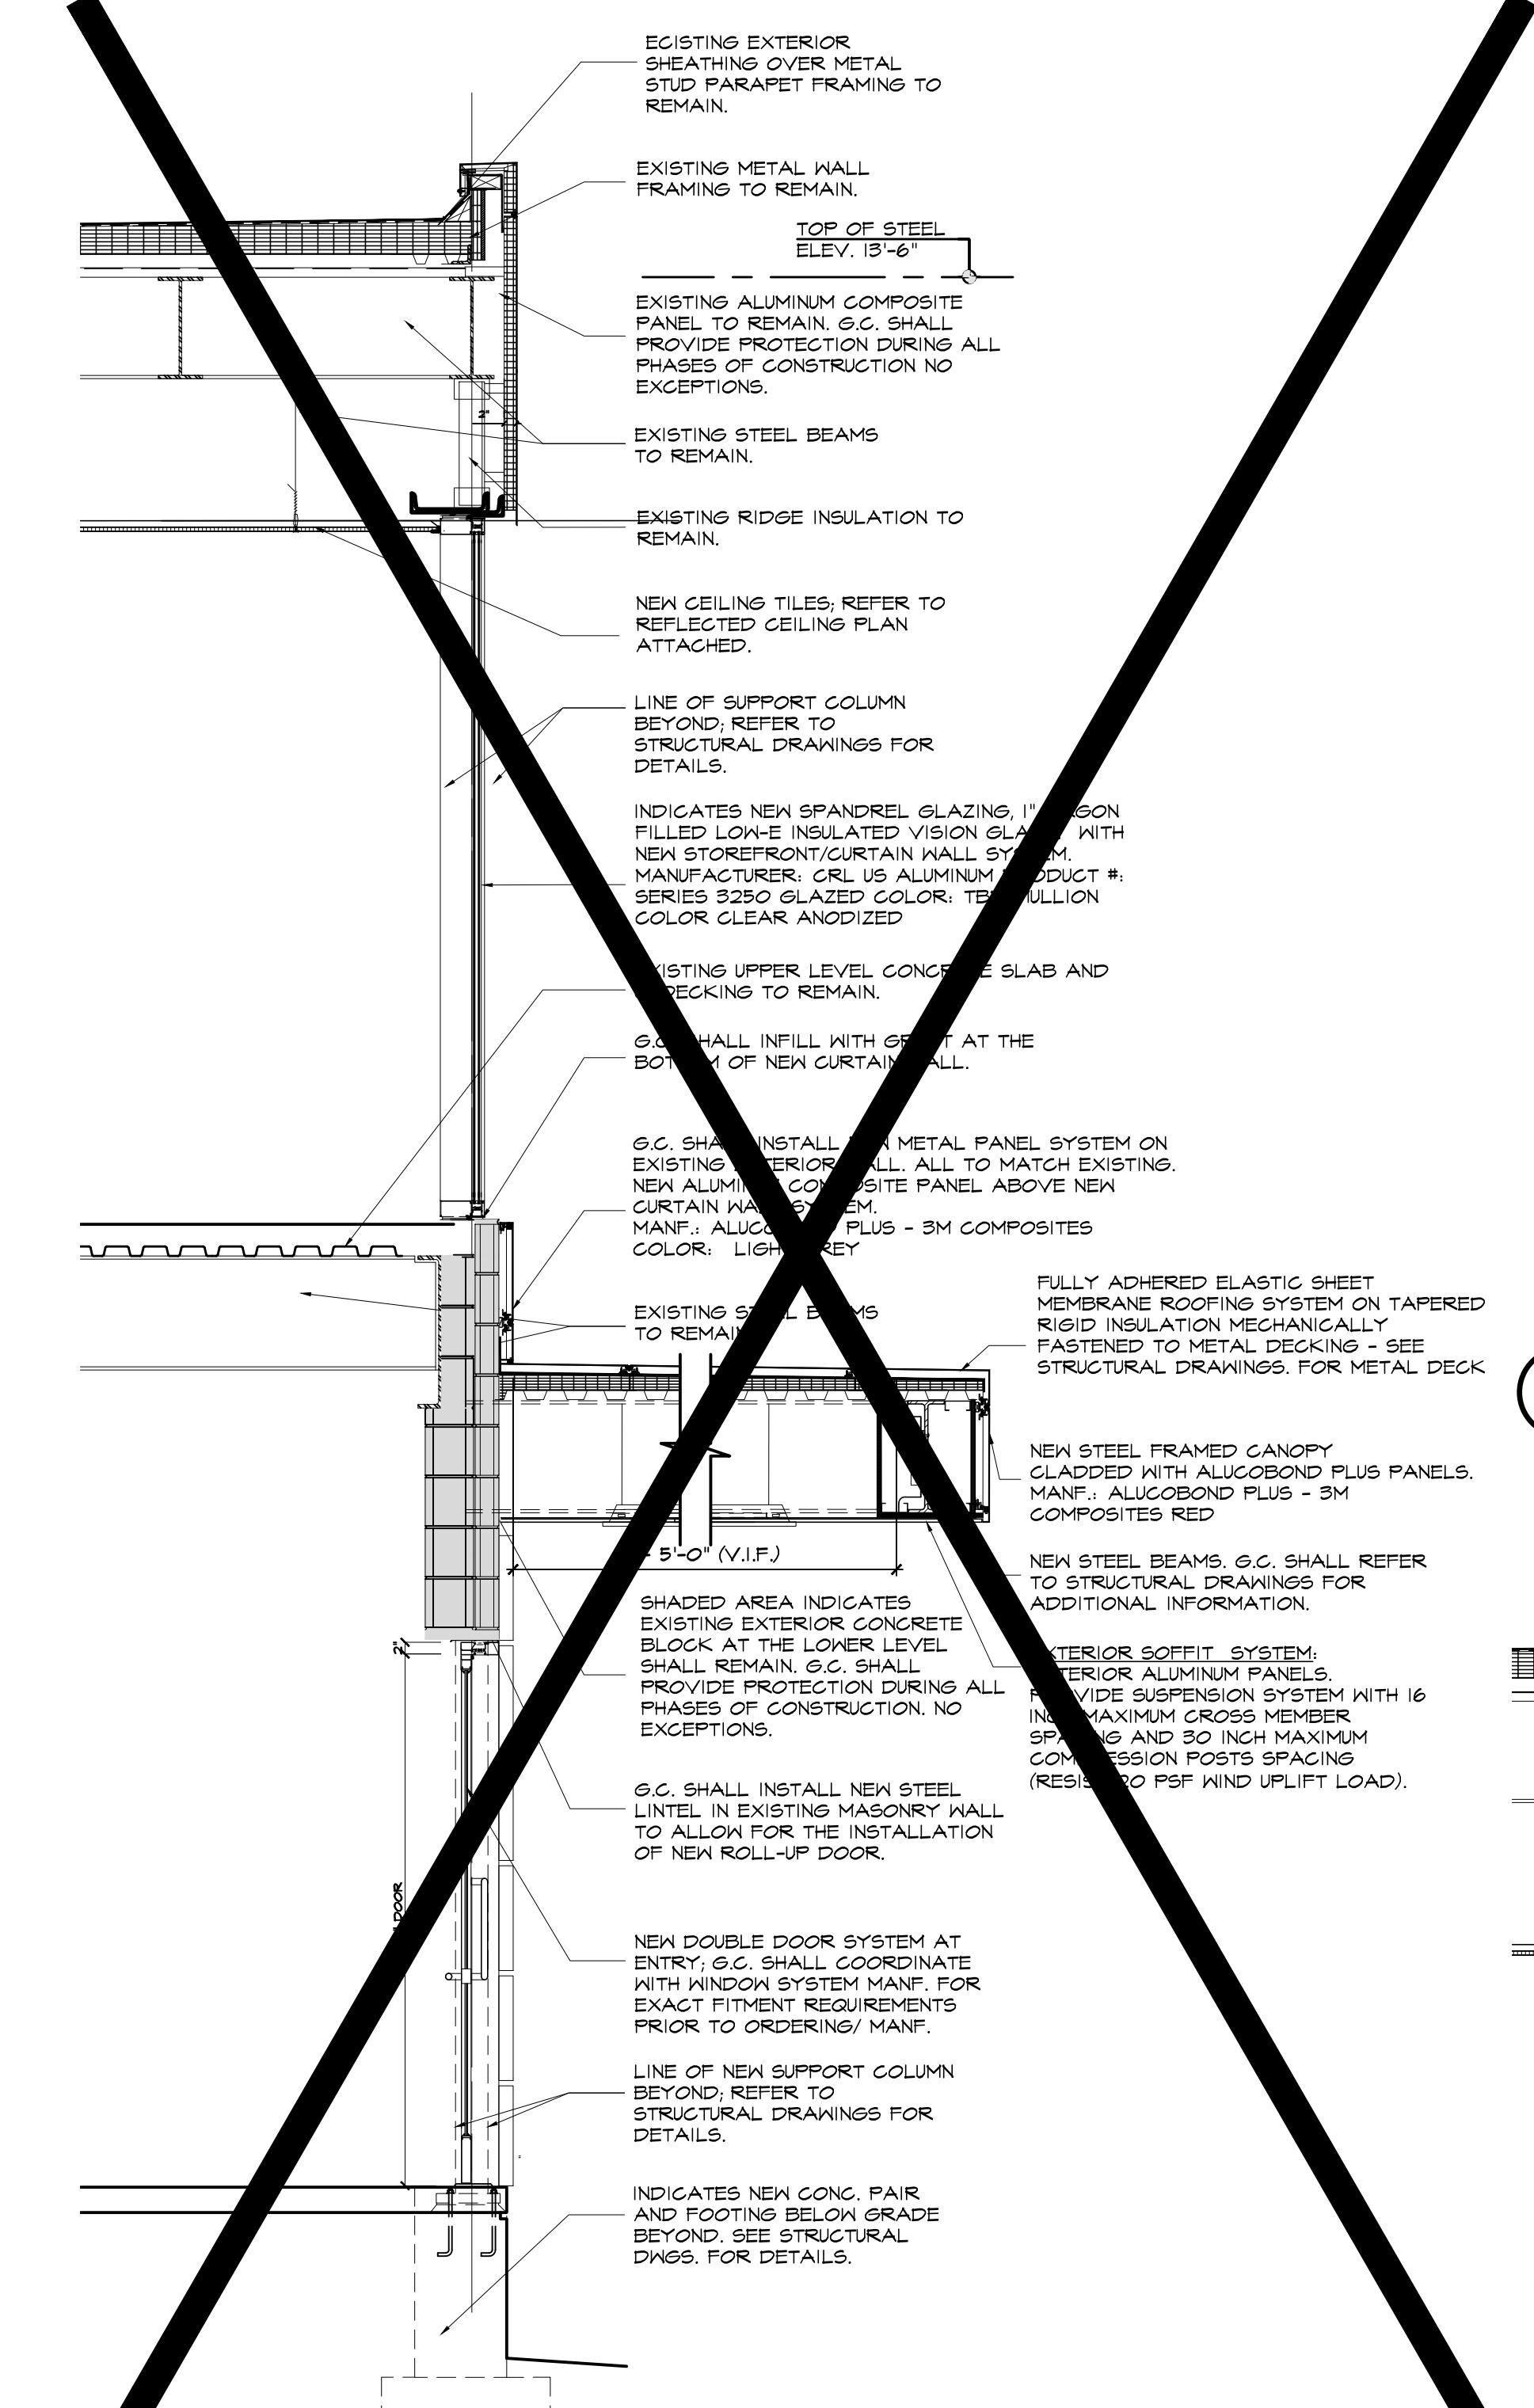

D DETAIL @ WALL VERTICAL JOINT  
SCALE: 1/2" = 1'-0"

E DETAIL @ WALL HORIZONTAL  
SCALE: 1/2" = 1'-0"

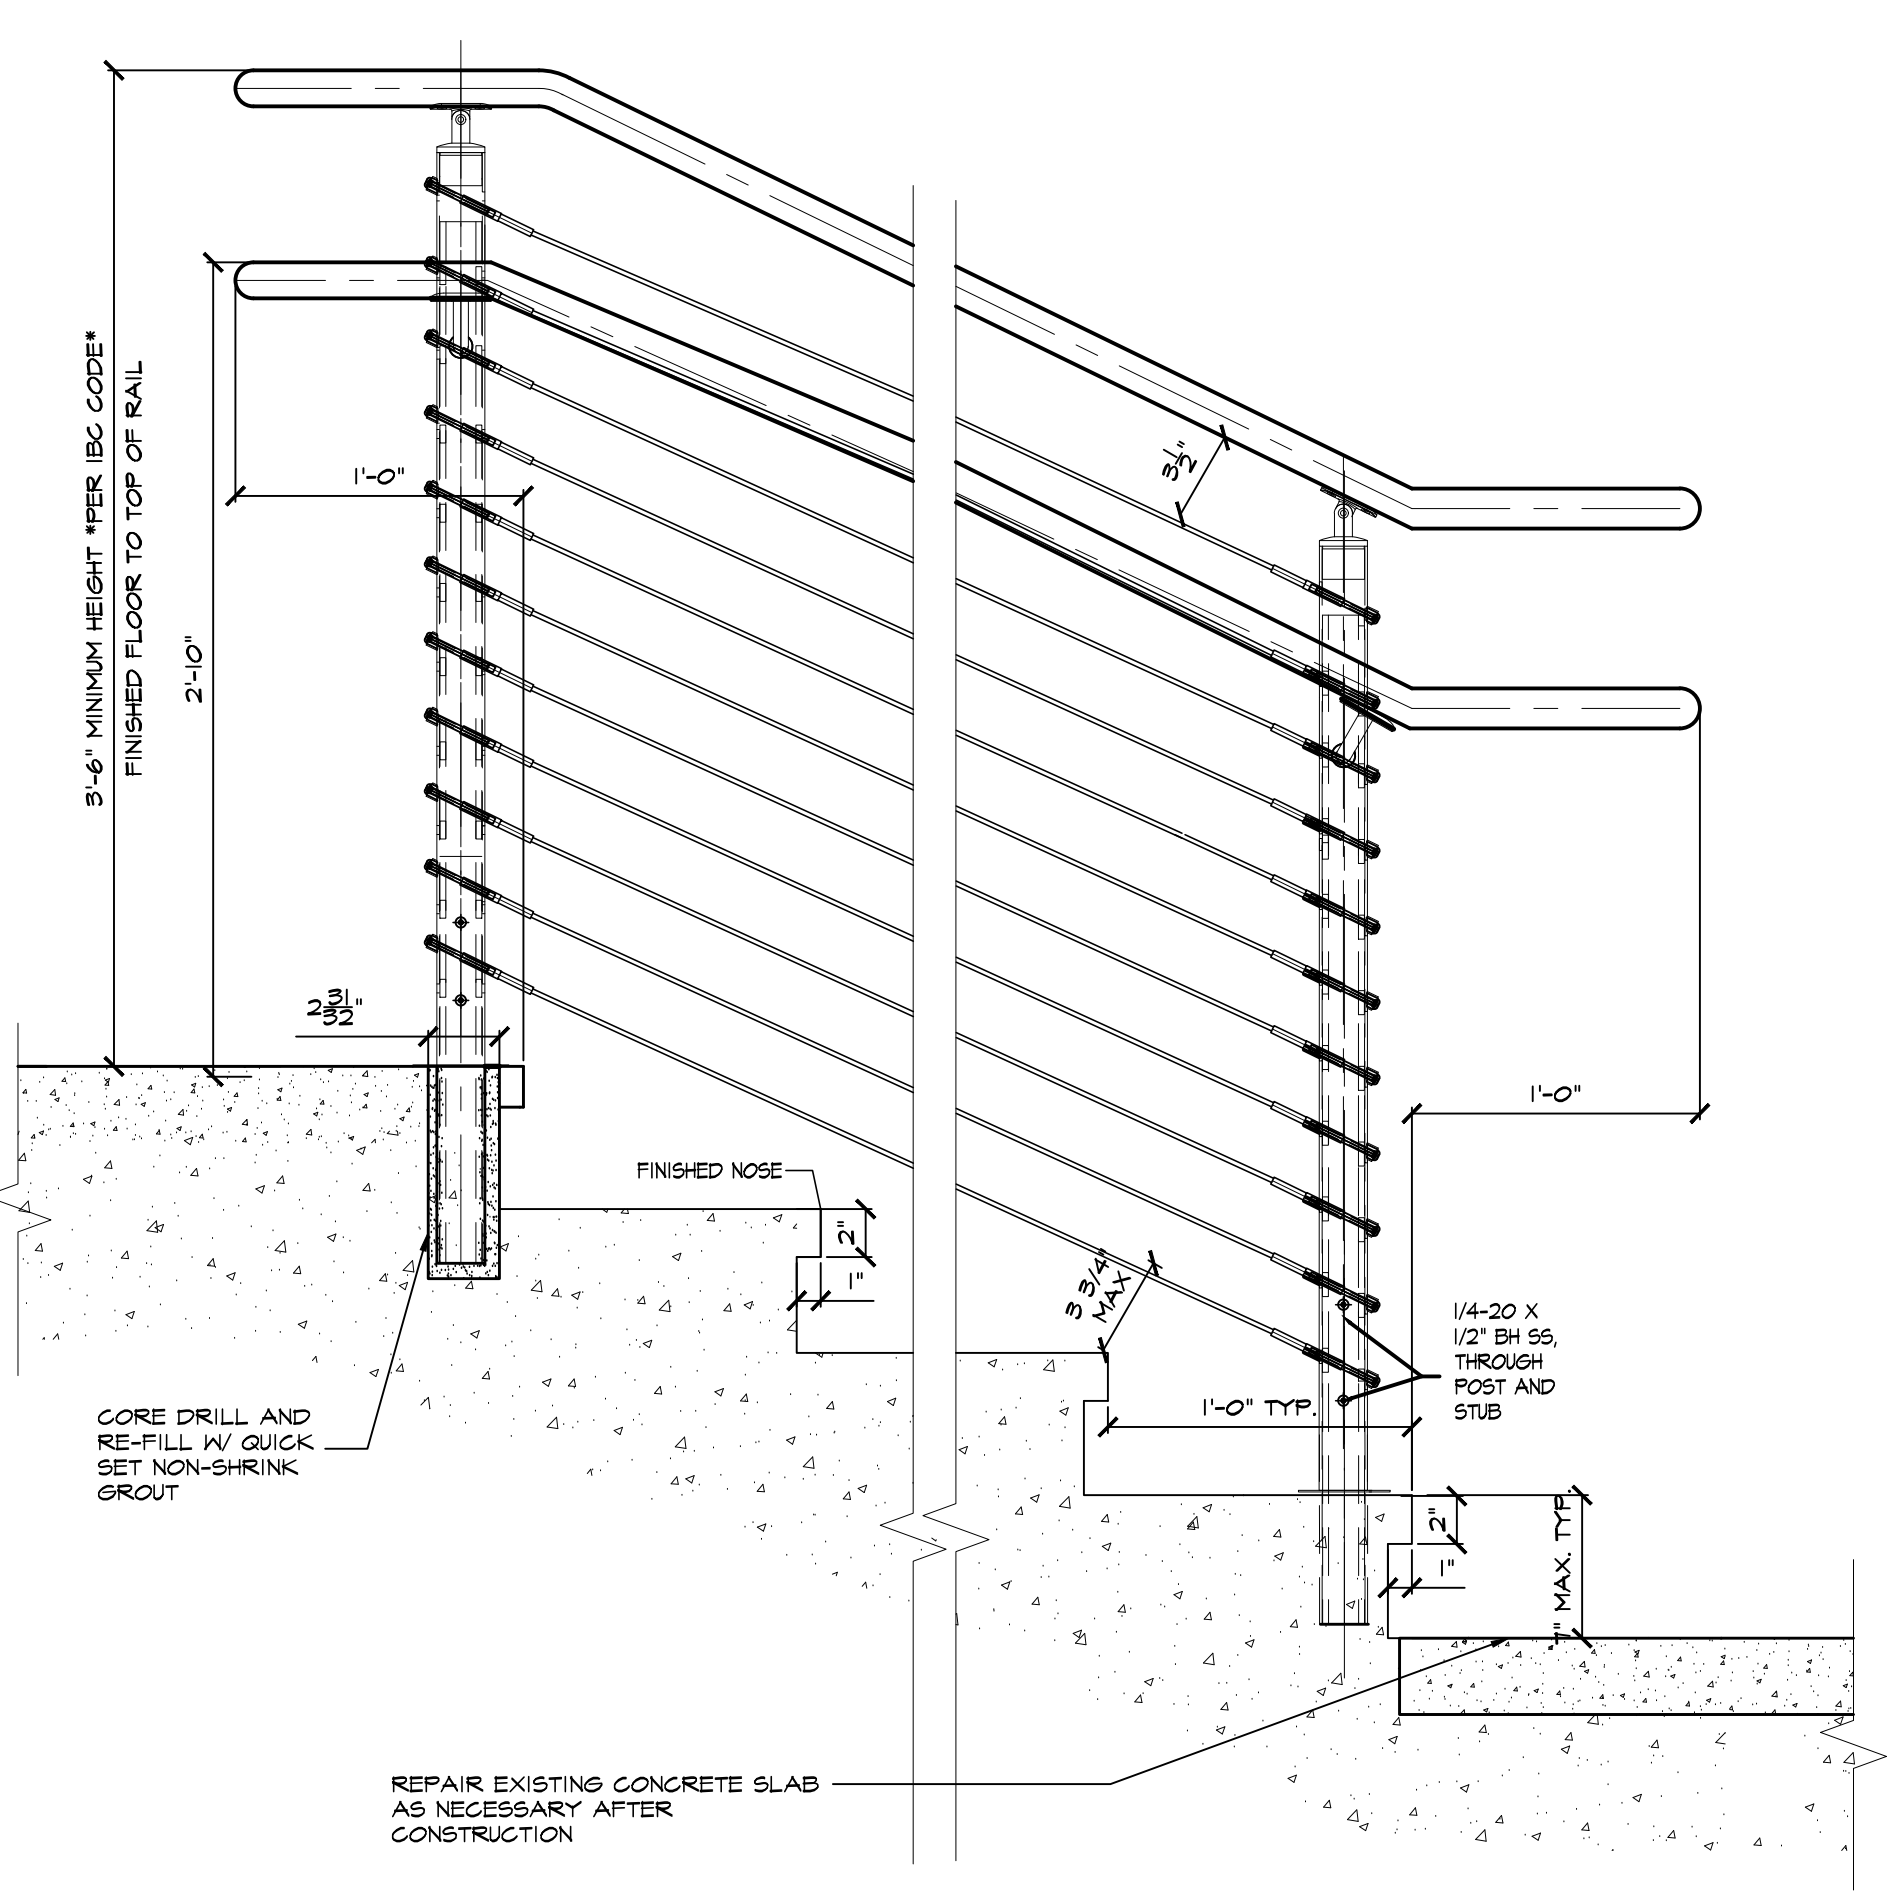

B TYP. SECTION @ STAIR TREADS  
SCALE: 1/2" = 1'-0"


NO.	DATE	DESCRIPTION
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3.	09/22/21	ISSUE FOR PLANNING BOARD REVIEW




SCALE	DATE	PROJECT NO.
AS NOTED	05/17/21	21-000-00

WALL SECTIONS


DRAWING NO: A5

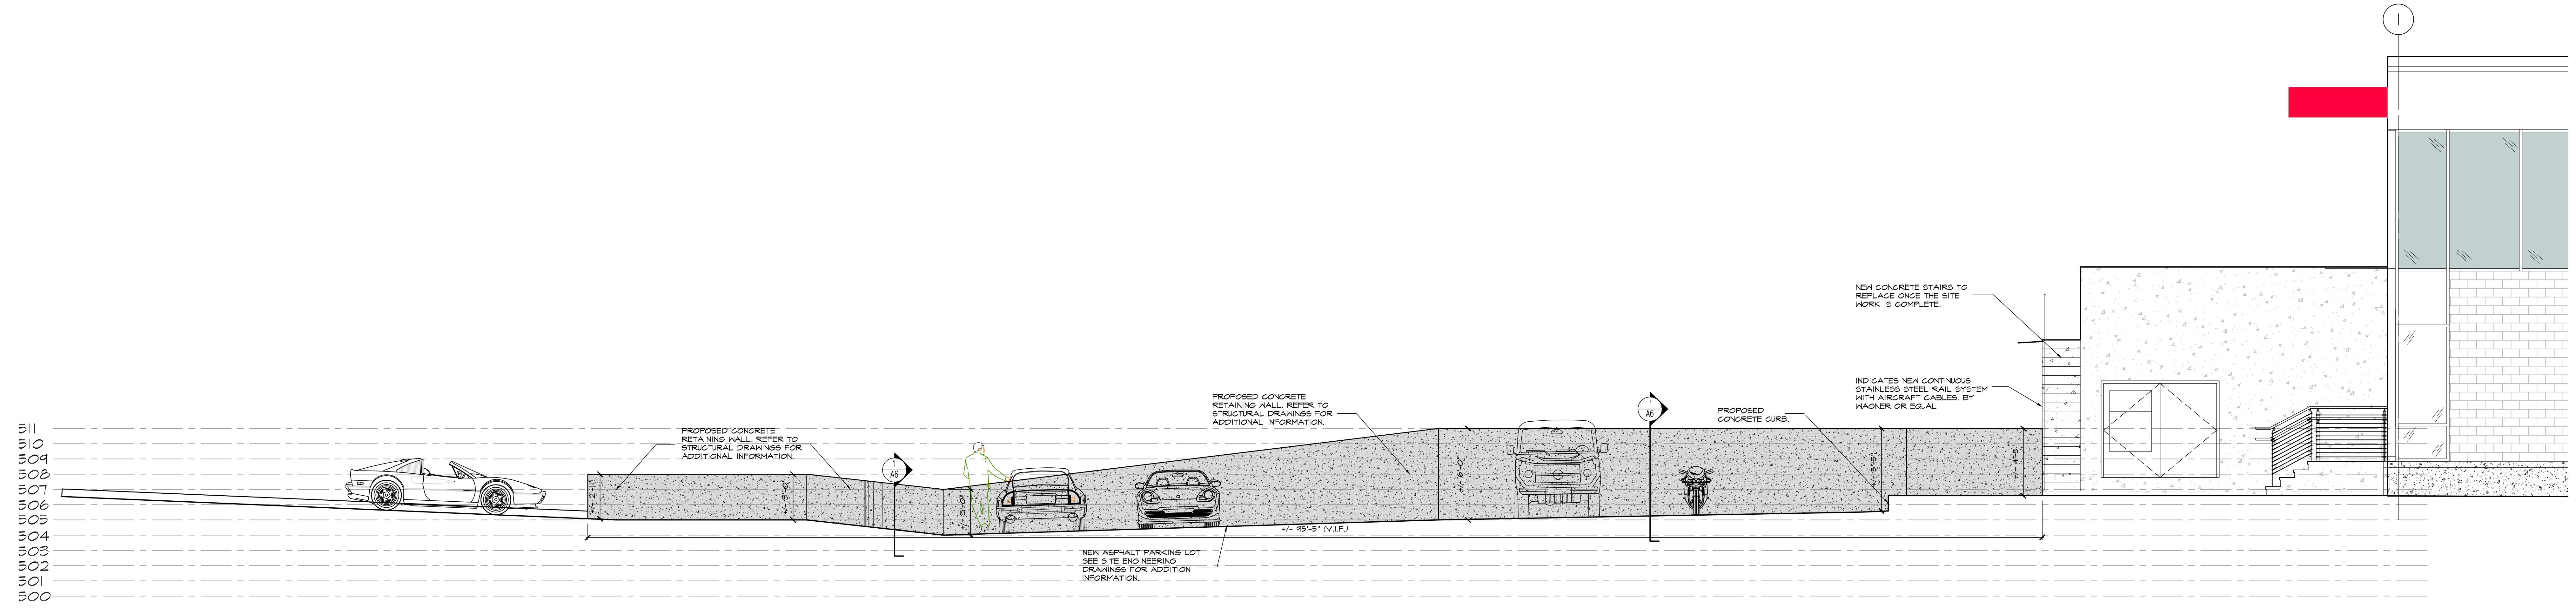

**A** PROPOSED RETAINING WALL ELEVATION  
SCALE: 1/8"=1'-0"

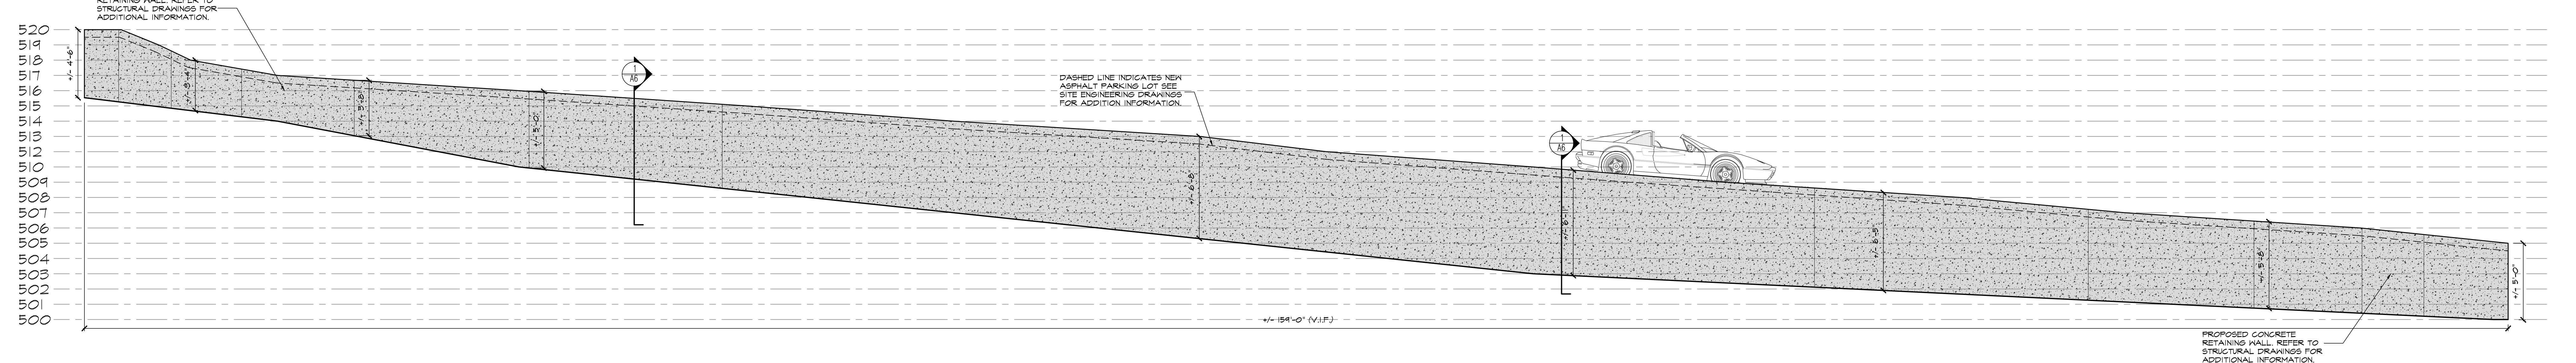

**B** PROPOSED RETAINING WALL ELEVATION  
SCALE: 1/8"=1'-0"

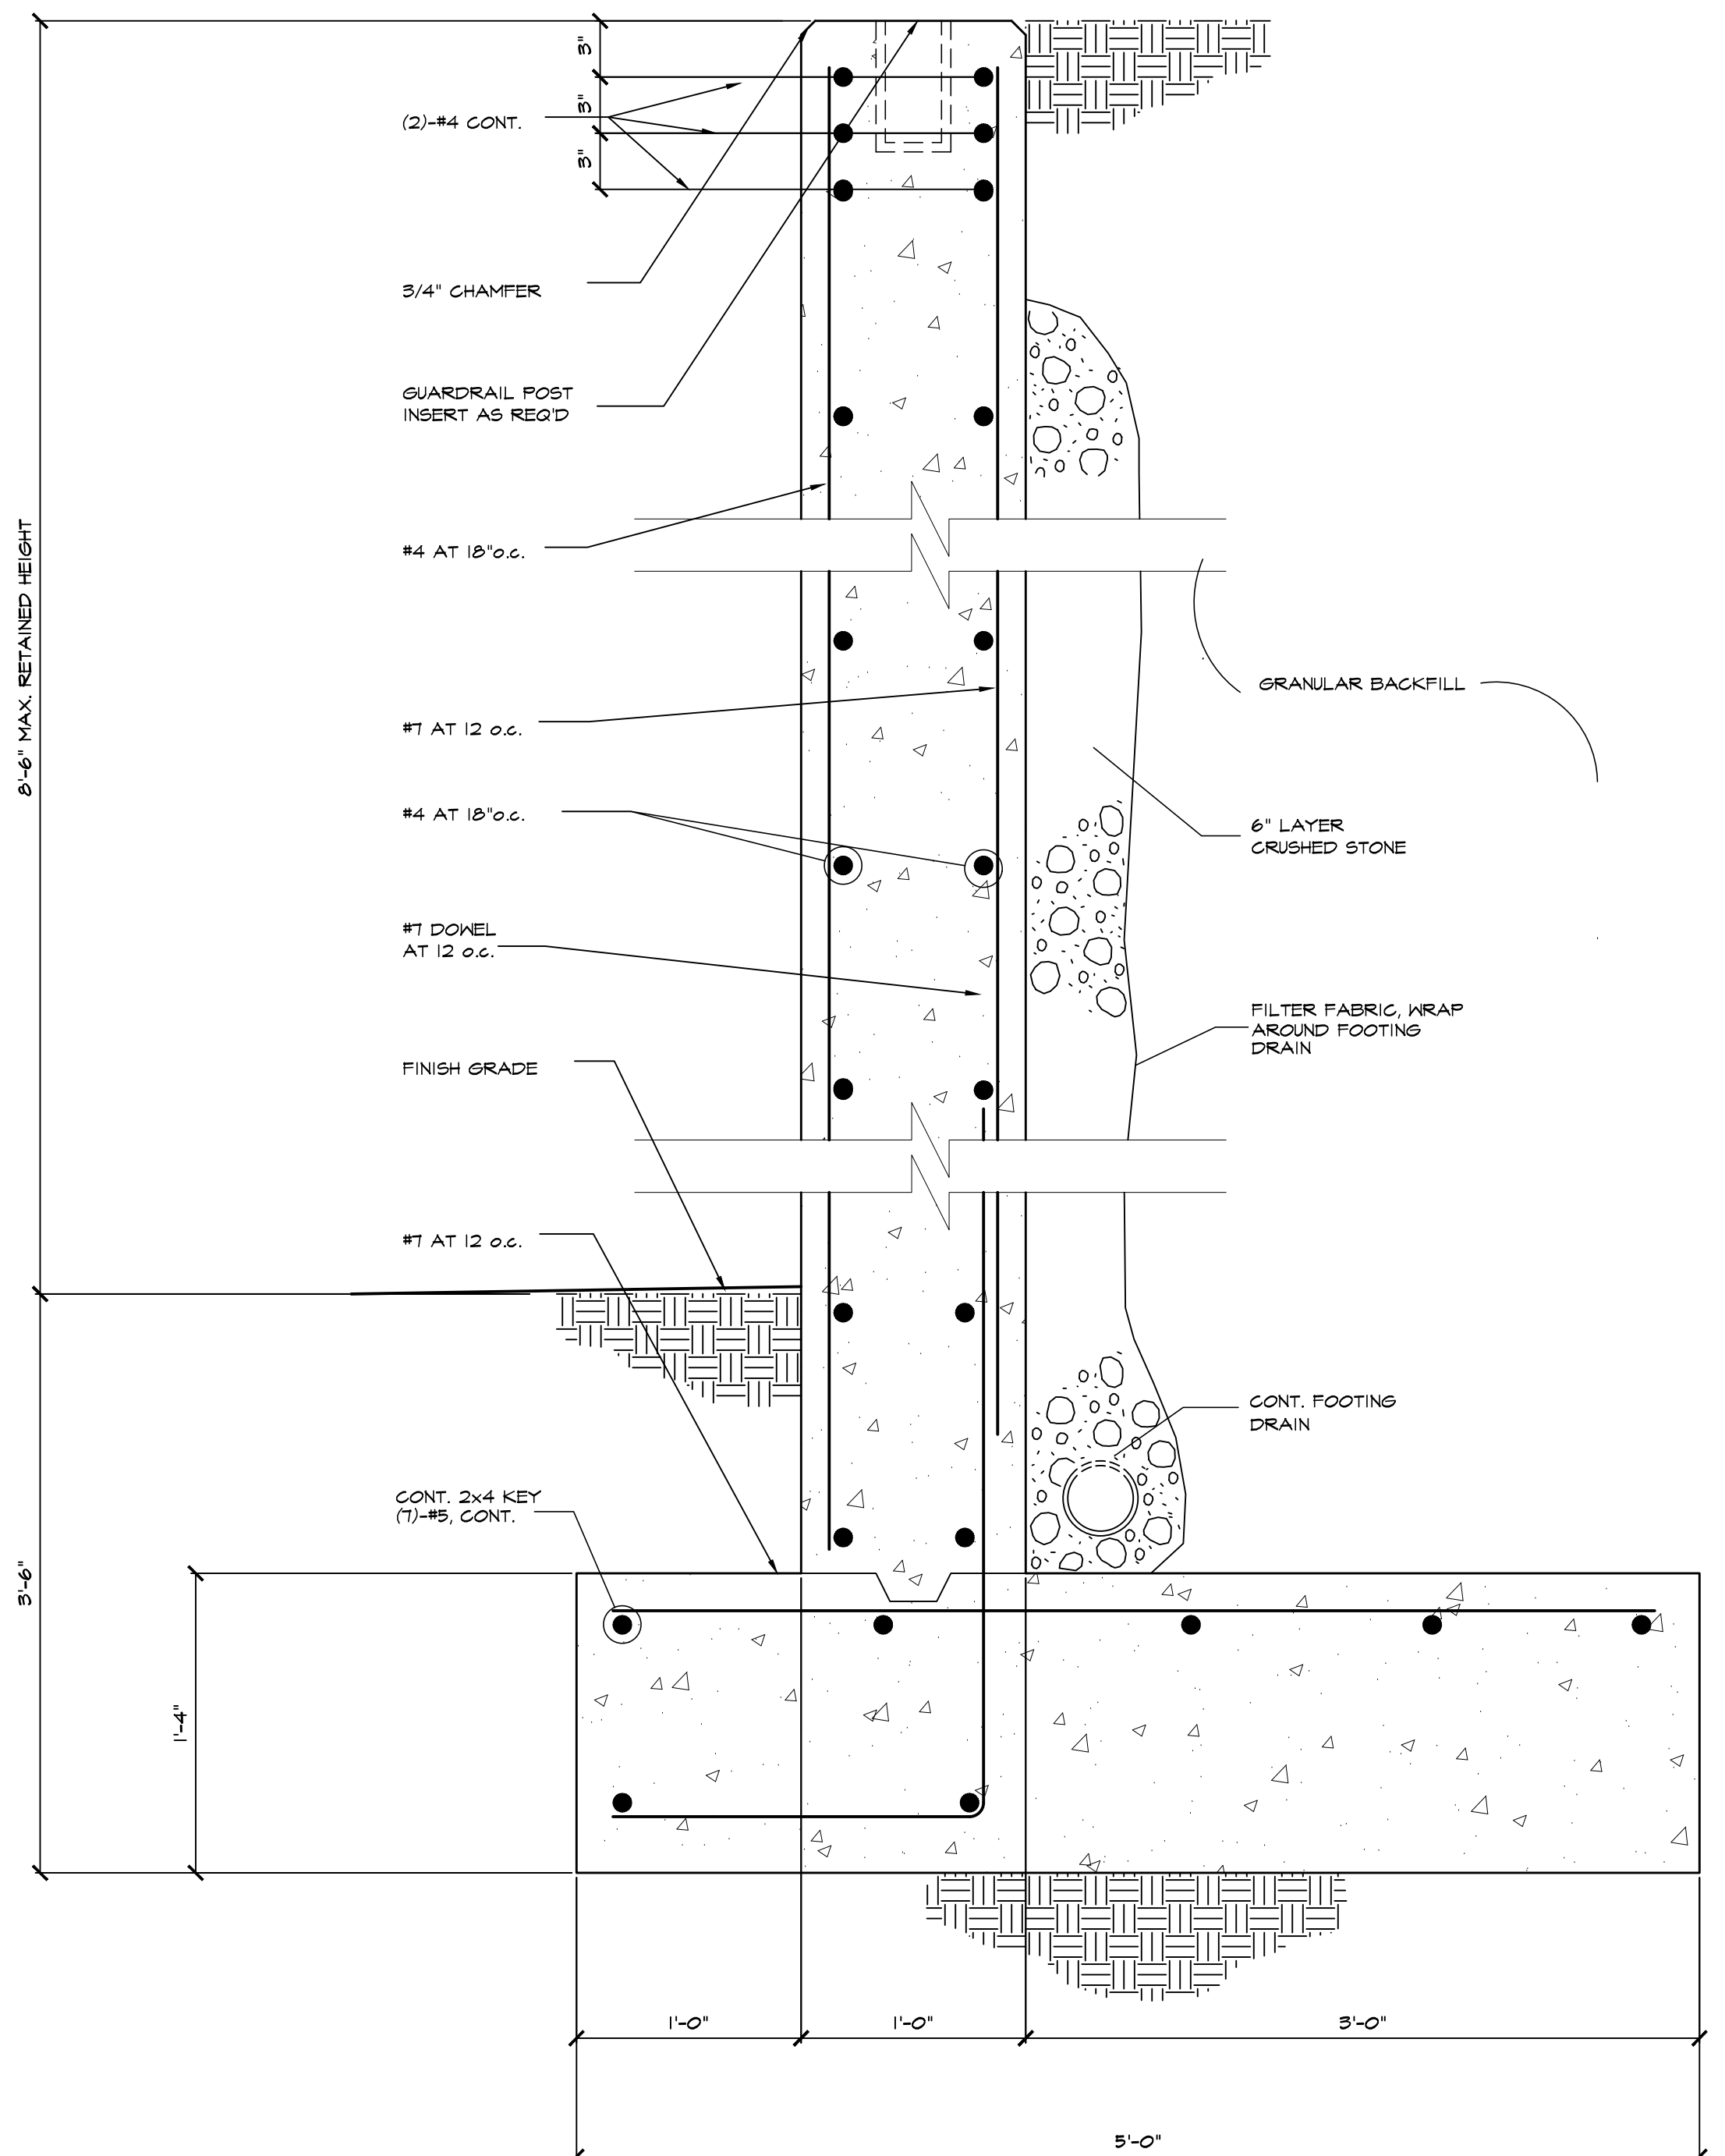


**1** RETAINING WALL DETAIL  
SCALE: 1/2"=1'-0"

PROJECT:  
**PROPOSED EXTERIOR BUILDING RENOVATIONS**  
**2651 STRANG BOULEVARD**  
**YORKTOWN HEIGHTS, NEW YORK 10598**  
**GROUND FLOOR**  
ZONE DISTRICT: OB / SECTION: 26.19 / BLOCK: 1 / LOT: 2

NO.	DATE	DESCRIPTION
1.	06/16/21	ISSUE FOR PLANNING BOARD REVIEW
2.	07/27/21	ISSUE FOR PLANNING BOARD REVIEW
3.	09/22/21	ISSUE FOR PLANNING BOARD REVIEW


SEAL



REGISTERED ARCHITECT  
GREGORY CARDARELLI  
02819  
STATE OF NEW YORK

SCALE: AS NOTED DATE: 05/17/21 PROJECT NO.: 21-000-00  
DRAWN BY: A.M. CHECKED BY: APPROVED BY:  
DRAWING TITLE: **RETAINING WALL DETAILS**



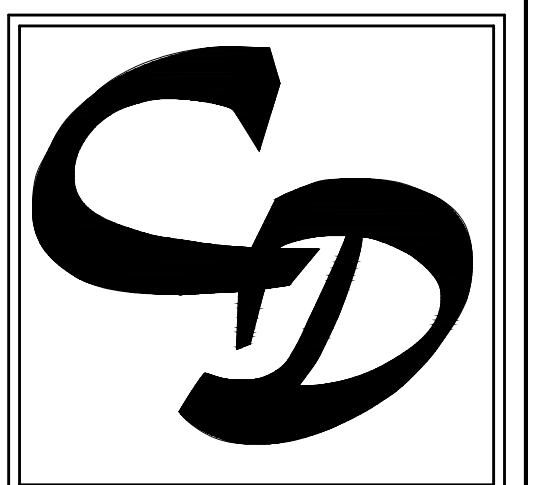

CARDARELLI  
DESIGN & ARCHITECTURE, P.C.  
297 KNOWLEDGE ROAD, SUITE 202  
WHITE PLAINS, NY 10607  
PHONE: 914-437-9554 / FAX: 914-437-9555



PROJECT: **PROPOSED EXTERIOR BUILDING RENOVATIONS**  
**2651 STRANG BOULEVARD**  
**YORKTOWN HEIGHTS, NEW YORK 10598**  
**GROUND FLOOR**  
ZONE DISTRICT: OB / SECTION: 26.19 / BLOCK: 1 / LOT: 2


NO.	DATE	DESCRIPTION
1.	06/17/21	ISSUE FOR PLANNING BOARD REVIEW
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3.	09/22/21	ISSUE FOR PLANNING BOARD REVIEW

SEAL

REGISTERED ARCHITECT  
STEFANO CARDARELLI  
STATE OF NEW YORK  
028819

SCALE: AS NOTED DATE: 05/17/21 PROJECT NO: 21-000-00  
DRAWN BY: A.M. CHECKED BY: APPROVED BY:  
DRAWING TITLE: **EXTERIOR LIGHTING LAYOUT**

DRAWING NO: **A7**

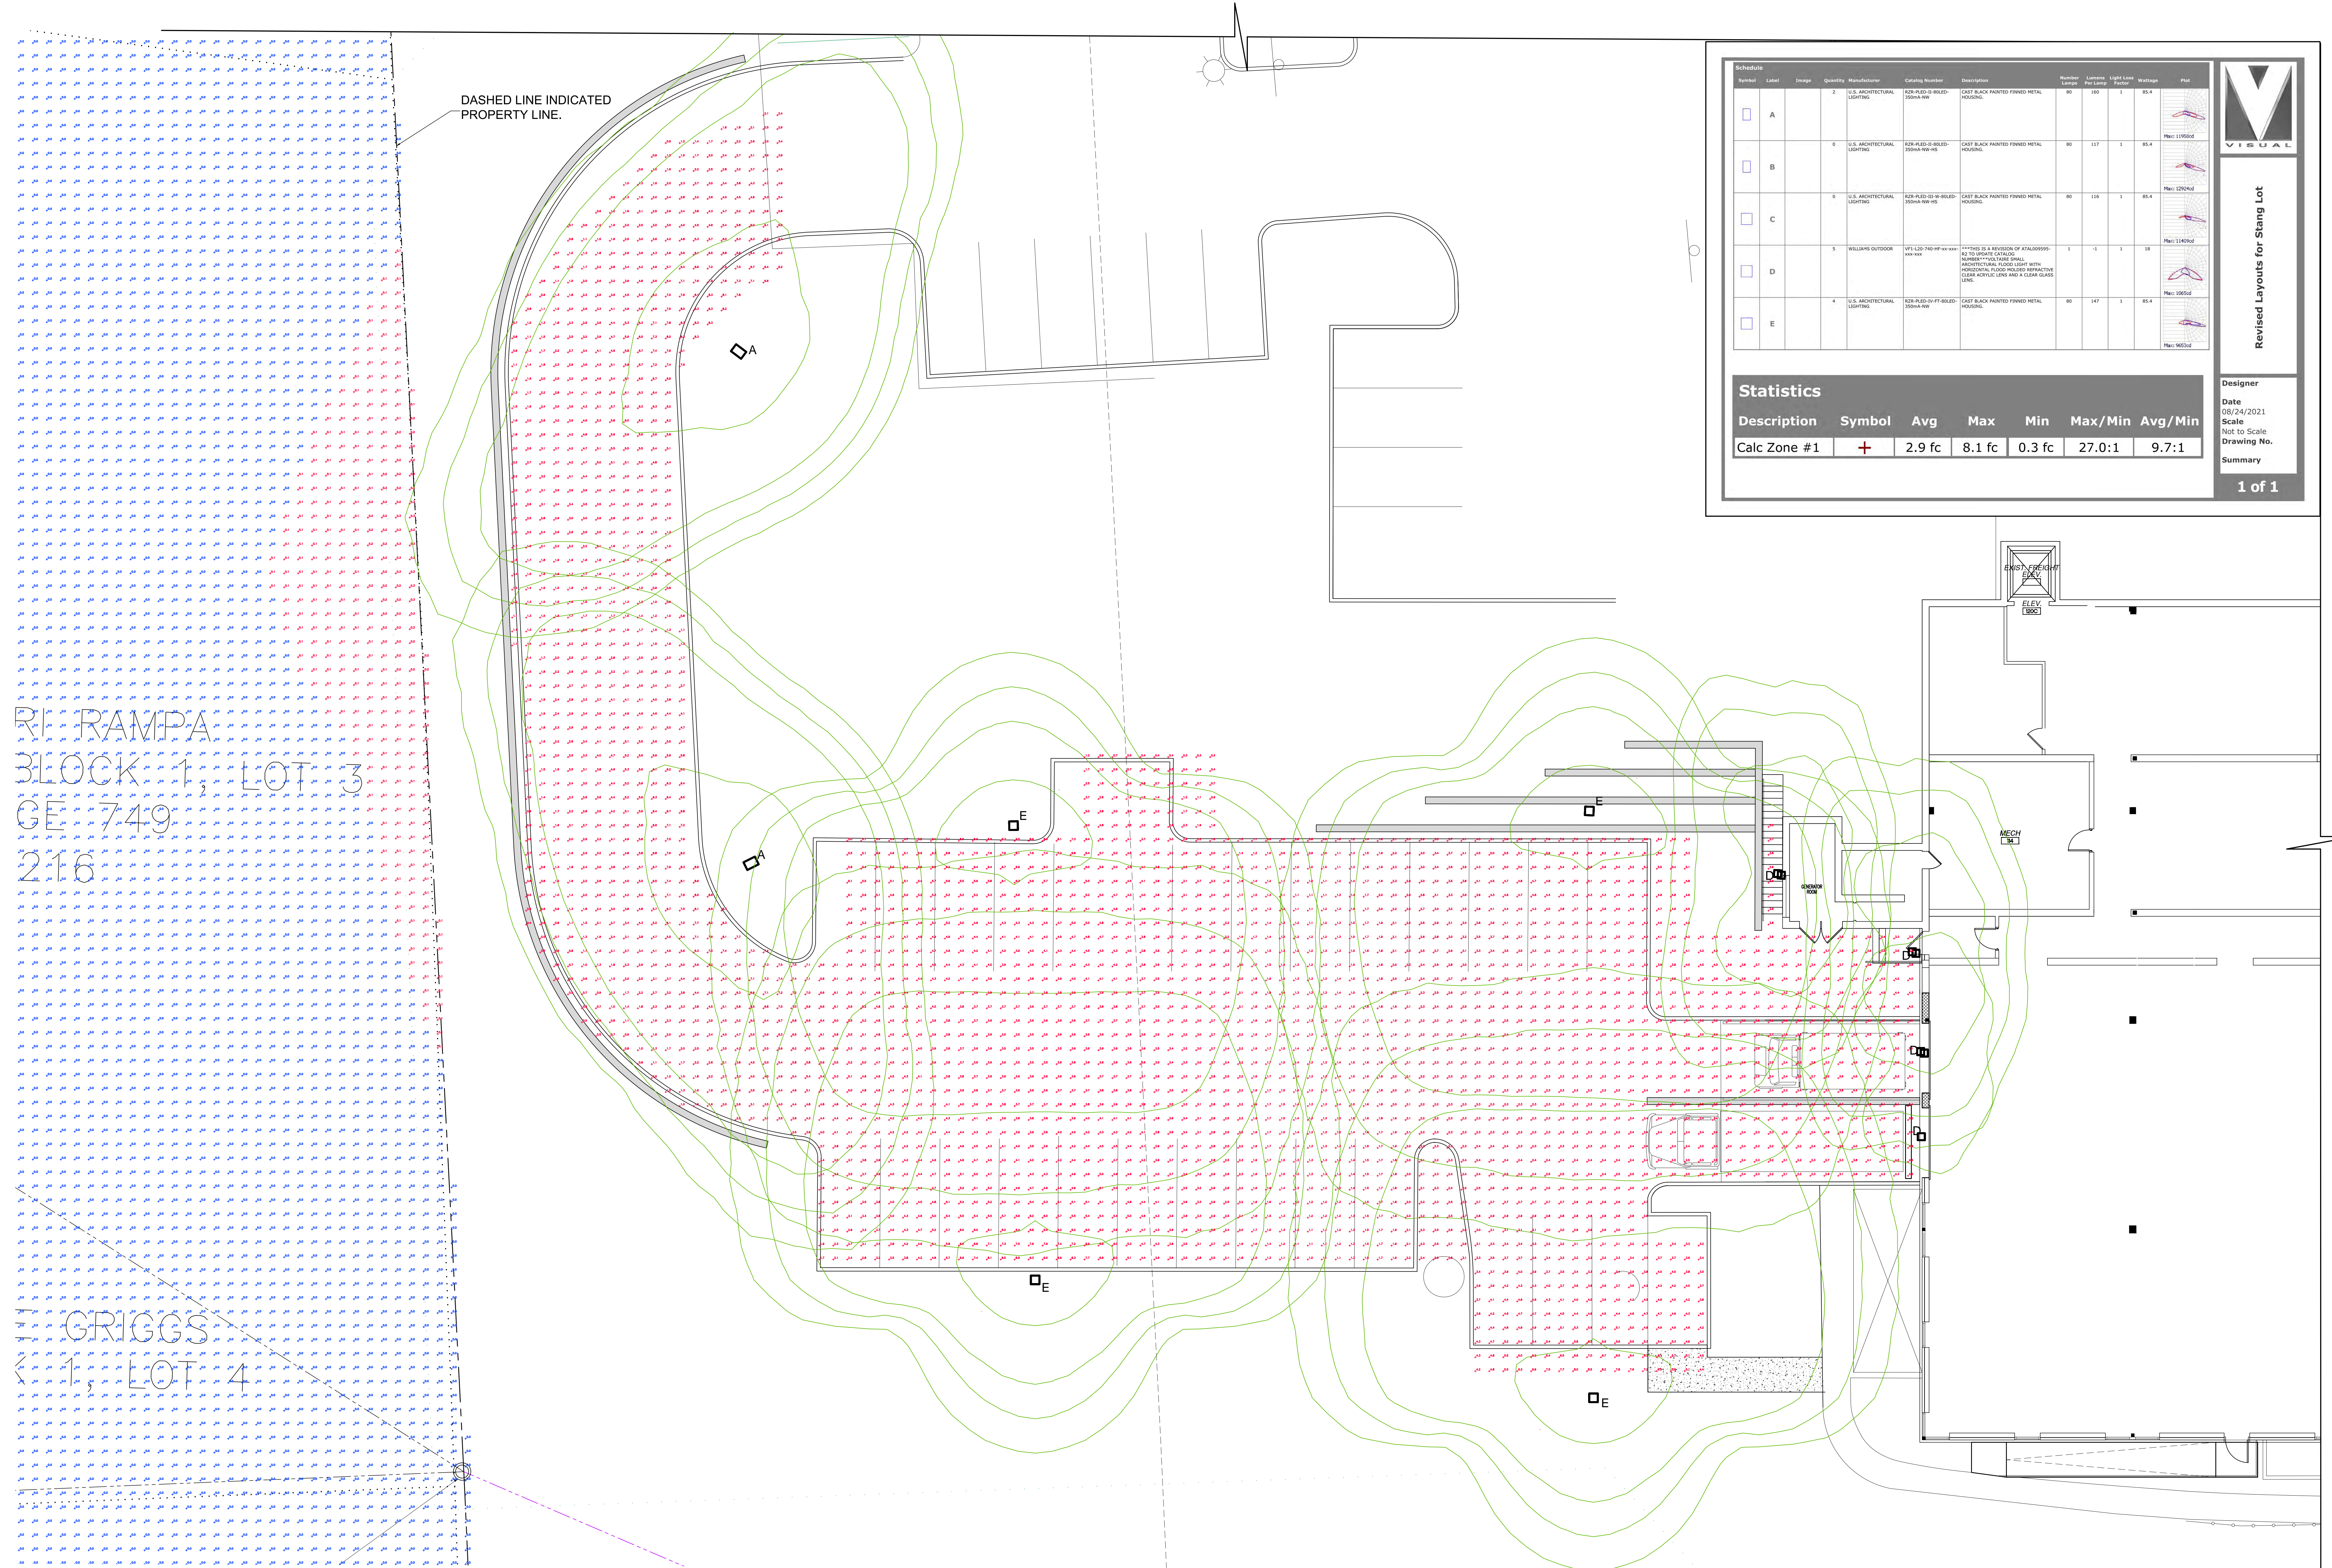

DASHED LINE INDICATED PROPERTY LINE.

RI RANPA  
BLOCK 1, LOT 3  
GE 749  
216

GRIGGS  
LOT 4

Schedule	Item	Level	Image	Quantity	Manufacturer	Catalog Number	Description	Number Per Fixture	Lot Area	Light Type	Power	Voltage	Plot
A				2	U.S. ARCHITECTURAL LIGHTING	SIZE PLED-36 H-ROLED-3000A-WH-1S	DAY BLACK PAINTED FINED METAL HOUSING	88	100	1	80.4		
B				0	U.S. ARCHITECTURAL LIGHTING	SIZE PLED-36 H-ROLED-3000A-WH-1S	DAY BLACK PAINTED FINED METAL HOUSING	88	117	1	80.4		
C				0	U.S. ARCHITECTURAL LIGHTING	SIZE PLED-36 H-ROLED-3000A-WH-1S	DAY BLACK PAINTED FINED METAL HOUSING	88	116	1	80.4		
D				5	WILLIAMS OUTDOOR	WFL-LED-780 HP W-1000-100-000	****THIS IS A REVISION OF A LUMINAIRE AS TO UPWARD CANNON LIGHTING. NUMBERING THIS LIGHT WITH HORIZONTAL FLOOD HAIRED REFLECTORS LOOK IDENTICAL TO THE CLEAR GLASS LENS	1	11	1	18		
E				4	U.S. ARCHITECTURAL LIGHTING	SIZE PLED-36 FT-BELED-3000A-WH	DAY BLACK PAINTED FINED METAL HOUSING	88	147	1	80.4		

Statistics

Description	Symbol	Avg	Max	Min	Max/Min	Avg/Min
Calc Zone #1	+	2.9 fc	8.1 fc	0.3 fc	27.0:1	9.7:1

Revised Layouts for Stang Lot

Designer: **STEFANO CARDARELLI**  
Date: 05/24/2021  
Scale: Not to Scale  
Drawing No.:  
Summary

1 of 1