SITE PLAN SET DELL AVENUE SOLAR FARM DELL AVENUE, YORKTOWN, NEW YORK 10514

RECEIVED
PLANNING DEPARTMENT
MAY 1 0 2023

TOWN OF YORKTOWN

PREPARED FOR: SCS DELL 014136 YORKTOWN, LLC

(SOL CUSTOMER SOLUTIONS, LLC)

1101 CONNECTICUT AVENUE NW, 2ND FLOOR


WASHINGTON, DC 20036

PREPARED BY: TRC ENGINEERS, INC.

1430 BROADWAY, 10TH FLOOR


NEW YORK, NEW YORK 10018

DATE: MAY 10, 2023 (REV. 3)

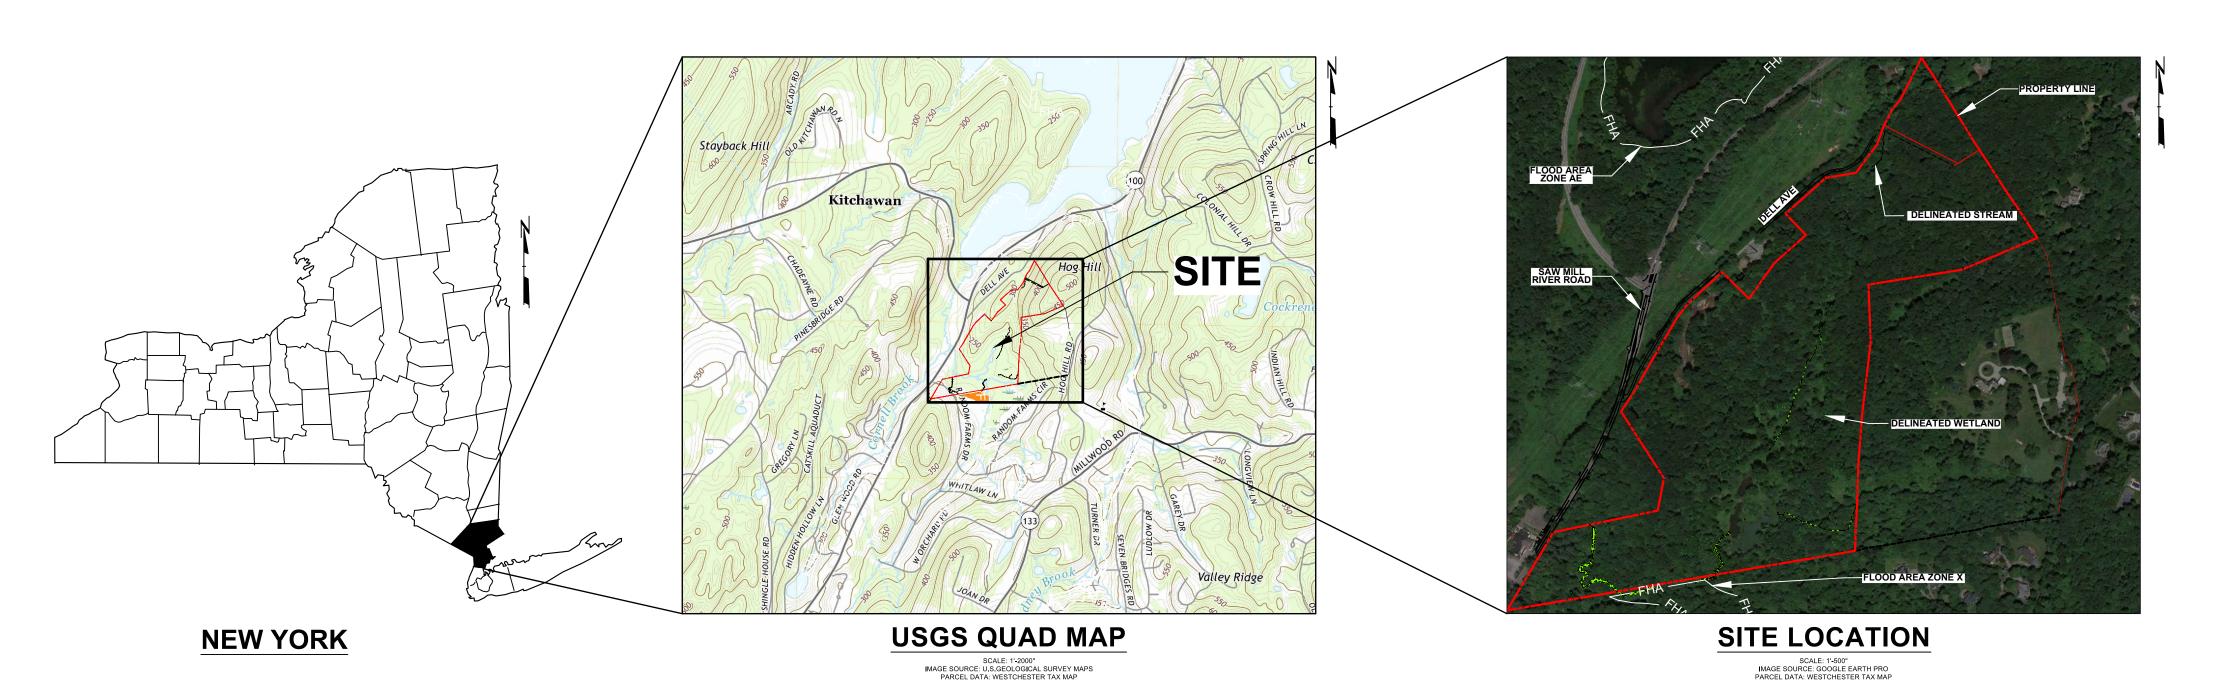

SHEET INDEX		
SHEET NUMBER	SHEET TITLE	LATEST REVISION DATE
G-101	TITLE SHEET	MAY 10, 2023
G-102	GENERAL NOTES MAY 10, 202	
C-101	EXISTING FEATURES MAY 10, 2023	
C-102	DEMOLITION PLAN	MAY 10, 2023
C-102A	SITE PLAN OVERVIEW	MAY 10, 2023
C-103	SITE PLAN - SOUTH	MAY 10, 2023
C-104	SITE PLAN - NORTH	MAY 10, 2023
C-105	GRADING PLAN - SOUTH	MAY 10, 2023
C-106	GRADING PLAN - NORTH	MAY 10, 2023
C-107	MICROPOOL 1A - PLAN	MAY 10, 2023
C-108	MICROPOOL 1A - PROFILE	MAY 10, 2023
C-109	BIORETENTION AREA 2A - PLAN	MAY 10, 2023
C-110	BIORETENTION AREA 2A - PROFILE	MAY 10, 2023
C-111	BIORETENTION AREA 2B & 3A - PLAN	MAY 10, 2023
C-112	BIORETENTION AREA 2B & 3A - PROFILES	MAY 10, 2023
C-113	DRY SWALES 1 & 2 - PLAN	MAY 10, 2023
C-114	DRY SWALES 1 & 2 - CROSS-SECTIONS	MAY 10, 2023
C-115	EROSION & SEDIMENT CONTROL PLAN - SOUTH	MAY 10, 2023
C-116	EROSION & SEDIMENT CONTROL PLAN - NORTH	MAY 10, 2023
L-101	LANDSCAPE PLAN - SOUTH	MAY 10, 2023
L-102	LANDSCAPE PLAN - NORTH	MAY 10, 2023
L-103	LANDSCAPE NOTES & DETAILS	SEPTEMBER 21, 2022
L-104	LANDSCAPE PLANTING TEMPLATE, SCHEDULES, & COORDINATE POINTS	SEPTEMBER 21, 2022
D-101	DETAILS SHEET 1	JUNE 14, 2022
D-102	DETAILS SHEET 2	SEPTEMBER 21, 2022
D-103	DETAILS SHEET 3	NOVEMBER 17, 2022
D-104	DETAILS SHEET 4	JUNE 14, 2022
D-105	DETAILS SHEET 5	JUNE 14, 2022
D-106	DETAILS SHEET 6	JUNE 14, 2022
D-107	DETAILS SHEET 7	MAY 10, 2023
D-108	DETAILS SHEET 8	AUGUST 30, 2022



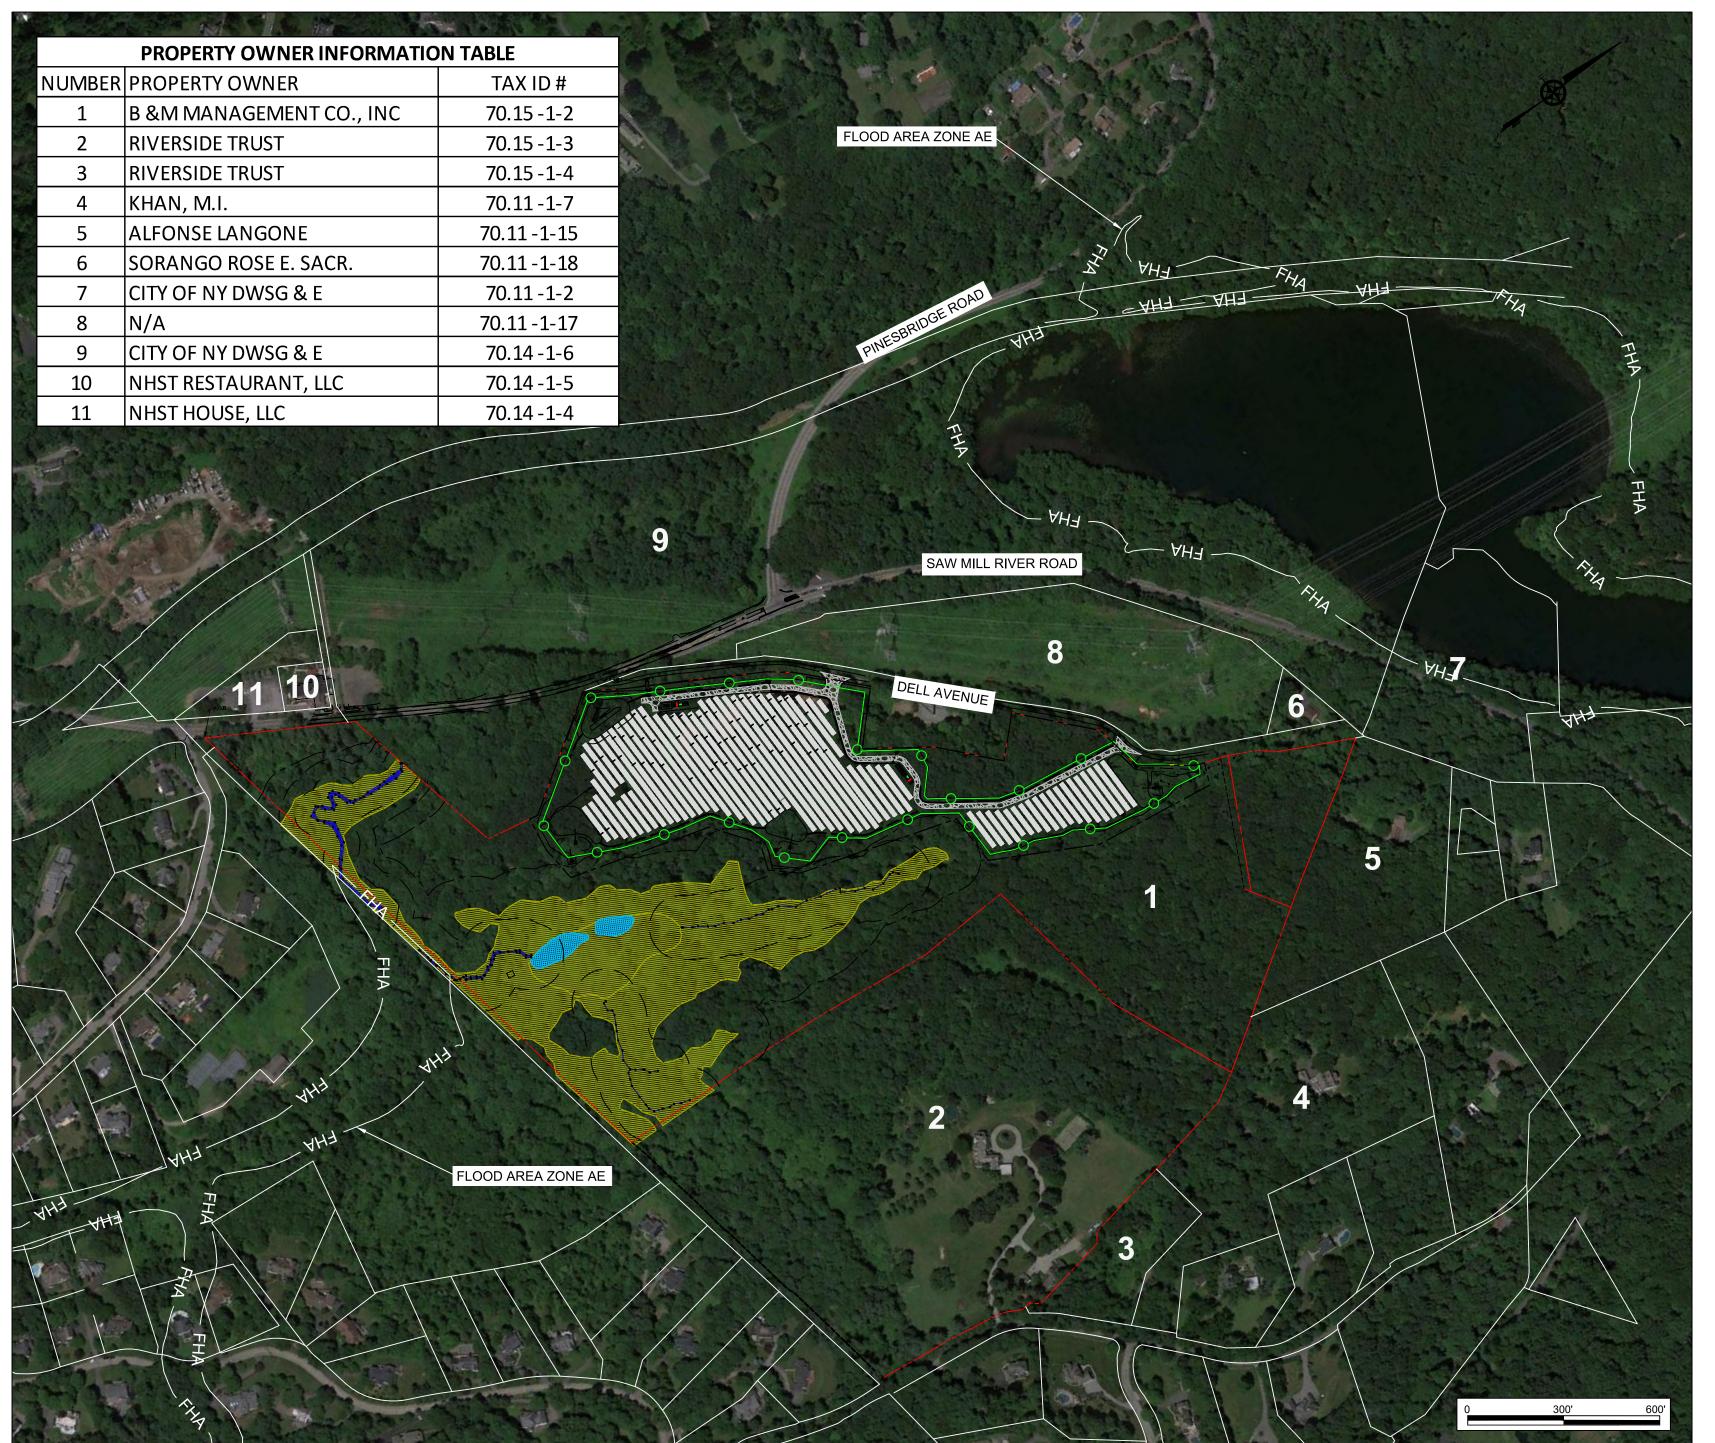

LAND USE INFORMATION				
LAND USE	UNIT	EXISTING	PROPOSED	
TOTAL PARCEL AREA	ACRES	62.3	62.3	
UNDISTURBED AREA	ACRES	62.3	47.4	
DISTURBED AREA	ACRES	N/A	15.0	
SOLAR AREA	ACRES	N/A	9.2	
WETLAND AREA	ACRES	13.3	13.3	
LEASE AREA	ACRES	N/A	18.9	
SITE DATA				

SITE DATA			
TAX ID #	PROPERTY OWNER	SITE ADDRESS	
70.15-1-2 70.11-01-16		70.15-01-02 & 70.11-01-16	
	B & M MANAGEMENT CO.	DELL AVENUE	
		YORKTOWN, NY, 10514	

ZONING CONFORMANCE TABLE				
ZONING CODE DESCRIPTION	ZONING CODE REQUIREMENT	PROPOSED PROJECT		
ZONING DESIGNATION	R1-160	R1-160		
MINIMUM LOT AREA (SQUARE FEET)	160,000	2,663,201		
MINIMUM LOT WIDTH (FEET)	200	2,890		
MINIMUM LOT DEPTH (FEET)	200	416		
MAXIMUM BUILDING HEIGHT (FEET)	MAIN BUILDING - 35 / ACCESSSORY BUILDING OR STRUCTURE -15	NOT APPLICABLE (EQUIPMENT HEIGHT IS NOT MORE THAN 10 FEET)		
FRONT YARD DEPTH (FEET)	75	116		
SIDE YARD DEPTH (FEET)	50	50		
REAR YARD DEPTH (FEET)	75	147		
ROAD FRONTAGE (FEET)	200	1,610		

GENERAL NOTES

- 1. THE PROJECT HORIZONTAL COORDINATES SYSTEM IS BASED ON NAD83 NEW YORK STATE PLANE (US SURVEY FEET, EAST ZONE, NY83-E) ELEVATIONS ARE BASED ON NAVD88 (US SURVEY FEET).
- 2. TOPOGRAPHY SHOWN ON THESE PLANS WAS COMPLETED BY LAND DESIGN ASSOCIATES ENGINEERING, SURVEYING AND LAND ARCHITECTURE D.P.C. USING A BASE & ROVER RTKGPS SYSTEM TO DEVELOP CONTOURS AT A 2 FOOT INTERVAL.
- 3. PROJECT PROPERTY BOUNDARIES ARE BASED ON INFORMATION PROVIDED BY LAND DESIGN ASSOCIATES ENGINEERING, SURVEYING AND
- LAND ARCHITECTURE D.P.C. LAND SURVEYING FROM A SURVEY COMPLETED IN OCTOBER 2019.
- 4. EXISTING UTILITIES ARE APPROXIMATE AND SHOULD BE VERIFIED BY CONTRACTOR. DIG SAFELY NEW YORK (811) SHALL BE NOTIFIED A MINIMUM OF 72-HOURS PRIOR TO COMMENCING ANY EXCAVATION.
- 5. FLOOD AREA AE IS THE CHANNEL OF A STREAM PLUS ANY ADJACENT FLOODPLAIN AREAS THAT MUST BE KEPT FREE OF ENCROACHMENT SO THAT THE 1% ANNUAL CHANCE FLOOD CAN BE CARRIED WITHOUT SUBSTANTIAL INCREASES IN FLOOD HEIGHTS. INFORMATION OBTAINED FROM FEMA FIRM MAPS #36119C0134F AND #36119C0133F.
- 6. FLOOD AREA X IS THE AREA OF 0.2% ANNUAL CHANCE FOOD; AREAS OF 1% ANNUAL CHANCE OF FLOOD WITH AVERAGE DEPTHS OF LESS THAN 1 FOOT OR WITH DRAINAGE AREAS LESS THAN 1 SQUARE MILE; AND AREAS PROTECTED BY LEVEES FROM 1% ANNUAL CHANCE FLOOD.INFORMATION OBTAINED FROM FEMA FIRM MAPS #36119C0134F AND #36119C0133F.
- THIS IS A PRELIMINARY DESIGN PLAN PROVIDED FOR PERMITTING ONLY. FINAL DESIGN SHALL BE MODIFIED TO SUPPORT CONSTRUCTION, MATCH FINAL ELECTRICAL INTERCONNECTION STUDIES, EQUIPMENT PURCHASED, AND POSSIBLE PERMIT CONSTRAINTS REVEALED DURING PROJECT'S REVIEW.
- 8. ALL WORK DETAILED ON THESE PLANS SHALL BE CONSTRUCTED IN ACCORDANCE WITH THE PROJECT SPECIFICATIONS, AND ANY OTHER
- APPLICABLE TECHNICAL REPORTS. WHERE INDICATED, STATE AND/OR LOCAL CODES AND STANDARD SPECIFICATIONS SHALL APPLY.

 9. THE CONTRACTOR SHALL ABIDE BY ALL LOCAL, STATE, AND FEDERAL LAWS, RULES AND REGULATIONS WHICH APPLY TO THE CONSTRUCTION OF THESE IMPROVEMENTS, INCLUDING STATE AND FEDERAL REQUIREMENTS.
- 10. THE CONTRACTOR IS RESPONSIBLE FOR PROTECTING ALL EXISTING UTILITY LINES WITHIN OR ADJACENT TO THE CONSTRUCTION AREA. ANY DAMAGE TO EXISTING FACILITIES CAUSED BY CONSTRUCTION ACTIVITY SHALL BE REPAIRED OR REPLACED AT THE CONTRACTOR'S
- 11. CONSTRUCTION SHALL NOT OCCUR IN ANY PUBLIC RIGHTS OF WAY, PUBLIC OR PRIVATE EASEMENTS, BEYOND THE LIMITS OF DISTURBANCE, OR OUTSIDE THE PROPERTY LIMITS WITHOUT NECESSARY PERMITS AND APPROVALS. ANY PUBLIC OR PRIVATE PROPERTY OR IMPROVEMENTS DAMAGED DURING CONSTRUCTION SHALL BE REPAIRED TO THE SATISFACTION OF THE OWNER AT THE COST OF THE
- CONTRACTOR.

 12. OVERNIGHT PARKING OF CONSTRUCTION EQUIPMENT SHALL NOT OBSTRUCT DRIVEWAYS OR DESIGNATED TRAFFIC LANES. THE CONTRACTOR SHALL NOT STORE ANY EQUIPMENT OR MATERIAL WITHIN THE PUBLIC RIGHT OF WAY. OVERNIGHT PARKING OF
- CONSTRUCTION VEHICLES ON PRIVATE PROPERTY IS THE SOLE RESPONSIBILITY OF THE CONTRACTOR.

 13. ALL PROPERTY CORNERS OR MONUMENTS DESTROYED DURING CONSTRUCTION SHALL BE REPLACED AT THE CONTRACTOR'S EXPENSE.
- ALL PROPERTY CORNERS MUST BE RESET BY A PROFESSIONAL LAND SURVEYOR LICENSED IN THE STATE OF NEW YORK.

 14. CONTRACTOR IS RESPONSIBLE FOR MAINTAINING DRAINAGE THROUGHOUT THE CONSTRUCTION OF THE PROJECT.
- 15. CONTRACTOR SHALL FIELD FIT ALL PROPOSED CULVERT INVERTS TO PROVIDE POSITIVE DRAINAGE IN THE DIRECTION OF EXISTING SLOPES. ALL CULVERTS TO BE INSTALLED AT ADEQUATE DEPTHS AND TO DAYLIGHT. INLETS AND OUTLETS OF ALL CULVERTS TO BE STABILIZED WITH RIP RAP IN ACCORDANCE WITH EROSION CONTROL PLAN.
- 16. THE CONTRACTOR SHALL SECURE PERMITS FROM THE STATE, COUNTY, AND TOWN AUTHORITIES AS NECESSARY BEFORE DRIVING CONSTRUCTION EQUIPMENT OVER AND ACROSS STATE, COUNTY OR TOWN MAINTAINED ROADS.
- 17. ALL WORK IN THE PUBLIC RIGHT OF WAYS SHALL CONFORM WITH THE NEW YORK DEPARTMENT OF TRANSPORTATION "STANDARD SPECIFICATIONS, CONSTRUCTION AND MATERIALS", DATED JANUARY 1, 2019 OR CURRENT EDITION.
- 18. WETLANDS AND WATERCOURSES SHOWN IN THIS PLAN ARE SUBJECT TO FUTURE CONFIRMATION BY NYSDEC.
- 19. THE EROSION AND SEDIMENTATION CONTROL MEASURES FOR THIS PROJECT SHALL BE IN COMPLIANCE WITH THE STORMWATER POLLUTION PREVENTION PLAN (SWPPP) PREPARED FOR THE PROJECT.
- 20. TREES AND OTHER VEGETATION IN AREAS OF IDENTIFIED CLEARING AND GRUBBING MAY BE REDUCED TO CHIPS BY THE USE OF CHIPPING MACHINES OR STUMP GRINDER AND BE PREPARED FOR USE AS EROSION CONTROL MIX. ALL OTHER CHIPS AND WOOD WASTE RESULTING FROM CLEARING AND GRUBBING OPERATIONS SHALL BE DISPOSED OF OFF-SITE AT AN APPROPRIATELY LICENSED FACILITY AND IN A MANNER AS APPROVED BY THE OWNER.
- 21. CONTRACTOR SHALL TAKE NECESSARY PRECAUTIONS TO AVOID DAMAGE TO EXISTING IMPROVEMENTS AND FACILITIES TO REMAIN IN PLACE. THE CONTRACTOR IS RESPONSIBLE FOR REPAIR AND REPLACEMENT OF DAMAGED ITEMS AS A RESULT OF CONSTRUCTION OF THE PROPOSED FACILITY.
- 22. THE WORK SHALL BE CARRIED OUT NEAR AND UNDER ENERGIZED EQUIPMENT. EXTREME CAUTION IS REQUIRED AT ALL TIMES. THE CONTRACTOR SHALL STRICTLY FOLLOW ALL APPLICABLE SAFETY REQUIREMENTS.
- 23. EARTHWORK: UNLESS EXPLICITLY STATED OTHERWISE, REFER TO THE LATEST EDITION OF THE STATE OF NEW YORK, DEPARTMENT OF TRANSPORTATION, STANDARDS SPECIFICATIONS, CONSTRUCTION AND MATERIALS, FOR GENERAL REQUIREMENTS, PRODUCTS, AND EXECUTION RELATED TO THE COMPLETION OF PROPOSED WORK.
- 24. THE LIMITS OF DISTURBANCE SHALL BE FIELD STAKED BY A LICENSED LAND SURVEYOR PRIOR TO THE START OF WORK. A COPY OF THE STAKEOUT SKETCH SHALL BE PROVIDED TO THE TOWN OF YORKTOWN.
- 25. PRIOR TO THE ISSUANCE OF A BUILDING PERMIT, THE APPLICANT SHALL SUBMIT A NOTICE OF INTENT (N.O.I.) TO THE NYSDEC AND PROVIDE
- PROOF OF COVERAGE UNDER THE SPDES GENERAL PERMIT FOR CONSTRUCTION ACTIVITIES TO THE TOWN OF YORKTOWN.

 26. ANY IMPORTED SOIL SHALL MEET THE NYSDEC STANDARDS OF UNRESTRICTED FILL AND BE SUITABLE FOR RESIDENTIAL USE. CONSTRUCTION DEBRIS IS NOT PERMITTED TO BE IMPORTED. ANY MATERIAL MEETING THE NYSDEC DEFINITION OF BENEFICIAL USE SHALL BE CERTIFIED AS SUCH BY THE DESIGN PROFESSIONAL OF RECORD. NOTIFY THE TOWN OF YORKTOWN PRIOR TO IMPORT. SOIL TESTING
- 27. PRIOR TO THE BACKFILLING OF ANY STORM WATER BEST MANAGEMENT PRACTICE, DOTS-ENGINEERING SHALL BE NOTIFIED TO PERFORM AN INSPECTION. CONTACT ENGINEERING AT 914-734-1060 TO SCHEDULE AN INSPECTION.
- 28. THE APPLICANT IS AWARE THAT THE ENTIRE SITE MUST BE 100% STABILIZED PRIOR TO THE ISSUANCE OF A CERTIFICATE OF OCCUPANCY. DISTURBED AREAS SHALL BE RESTORED AND STABILIZED APPROPRIATELY AND IN A TIMELY MANNER. APPLICANT SHALL SUBMIT A NOTICE OF TERMINATION FOR THE SPDES GENERAL PERMIT.
- 29. PRIOR TO THE ISSUANCE OF A CERTIFICATE OF OCCUPANCY, AN "AS-BUILT" SURVEY PREPARED BY A LICENSED PROFESSIONAL LAND SURVEYOR OF THE PROPERTY SHALL BE SUBMITTED TO THE DEPARTMENT OF TECHNICAL SERVICES.
- 30. ALL DEMOLITION DEBRIS INCLUDING FOUNDATIONS AND SLABS SHALL BE LAWFULLY DISPOSED OF OFF-SITE. ROCK FROM WALLS SHALL BE STOCKPILED ON-SITE.
- 31. ELECTRICAL DESIGN PROVIDED HEREON WAS PREPARED BY SOL SYSTEMS, LLC.

MAY STILL BE REQUIRED.

32. ABSOLUTELY NO RECYCLED MATERIAL SHALL BE PERMITTED ONSITE. ONLY EARTHEN MATERIAL OR NATURAL STONE IS PERMITTED TO BE USED AS FILL. ALL FILL SHALL BE TESTED IN ACCORDANCE WITH APPLICABLE NYSDEC RULES AND REGULATIONS AND SHALL BE CERTIFIED AS UNRESTRICTED FOR RESIDENTIAL USE, CERTIFIED BY A PROFESSIONAL ENGINEER PRIOR TO IMPORTATION ON SITE, AND SHALL BE FROM A CERTIFIED VIRGIN SOURCE.



1430 Broadway, 10th
New York, NY 1
Phone: 212.221
www.TRCcompanies

Systems, LLC lecticut Avenue NW

Sol Systems, I 1101 Connecticut Av 2nd Floor Washington DC



Revisions:		
No.	Date:	
1	SEPTEMBER 21, 2022	
2	NOVEMBER 17, 2022	
3	MAY 10, 2023	

Drawn by:
A. REXROAT

S. MEERSMA

hecked by:

Approved by:

C. DUNCAN

SCS DELL 014136 YORKTOWN, LLC
DELL AVENUE SOLAR FARM
FIXED-TILT GROUND MOUNT SOLAR ENERGY SYSTEN
DELL AVENUE, YORKTOWN, NEW YORK 10514

Contract No. **431302**

Scale: AS SHOWN

AUGUST 30, 2022

Sheet:
GENERAL NOTES


Drawing No:
G-102


NOTE:UNDER NEW YORK STATE EDUCATION LAW ARTICLE 145
(ENGINEERING), SECTION 7209 (2), IT IS A VIOLATION FOR ANY
PERSON, UNLESS ACTING UNDER THE DIRECTION OF A LICENSED
PROFESSIONAL ENGINEER, TO ALTER THIS DOCUMENT.


NOT FOR CONSTRUCTION


NOTE: THESE PLANS ARE ACCOMPANIED BY SUPPLEMENTAL DOCUMENTS. THESE DOCUMENTS ARE INTERRELATED AND ARE INTENDED TO BE USED TOGETHER. THESE DOCUMENTS ARE INTENDED TO BE USED FOR LOCAL APPROVAL PURPOSES

NOT FOR CONSTRUCTION

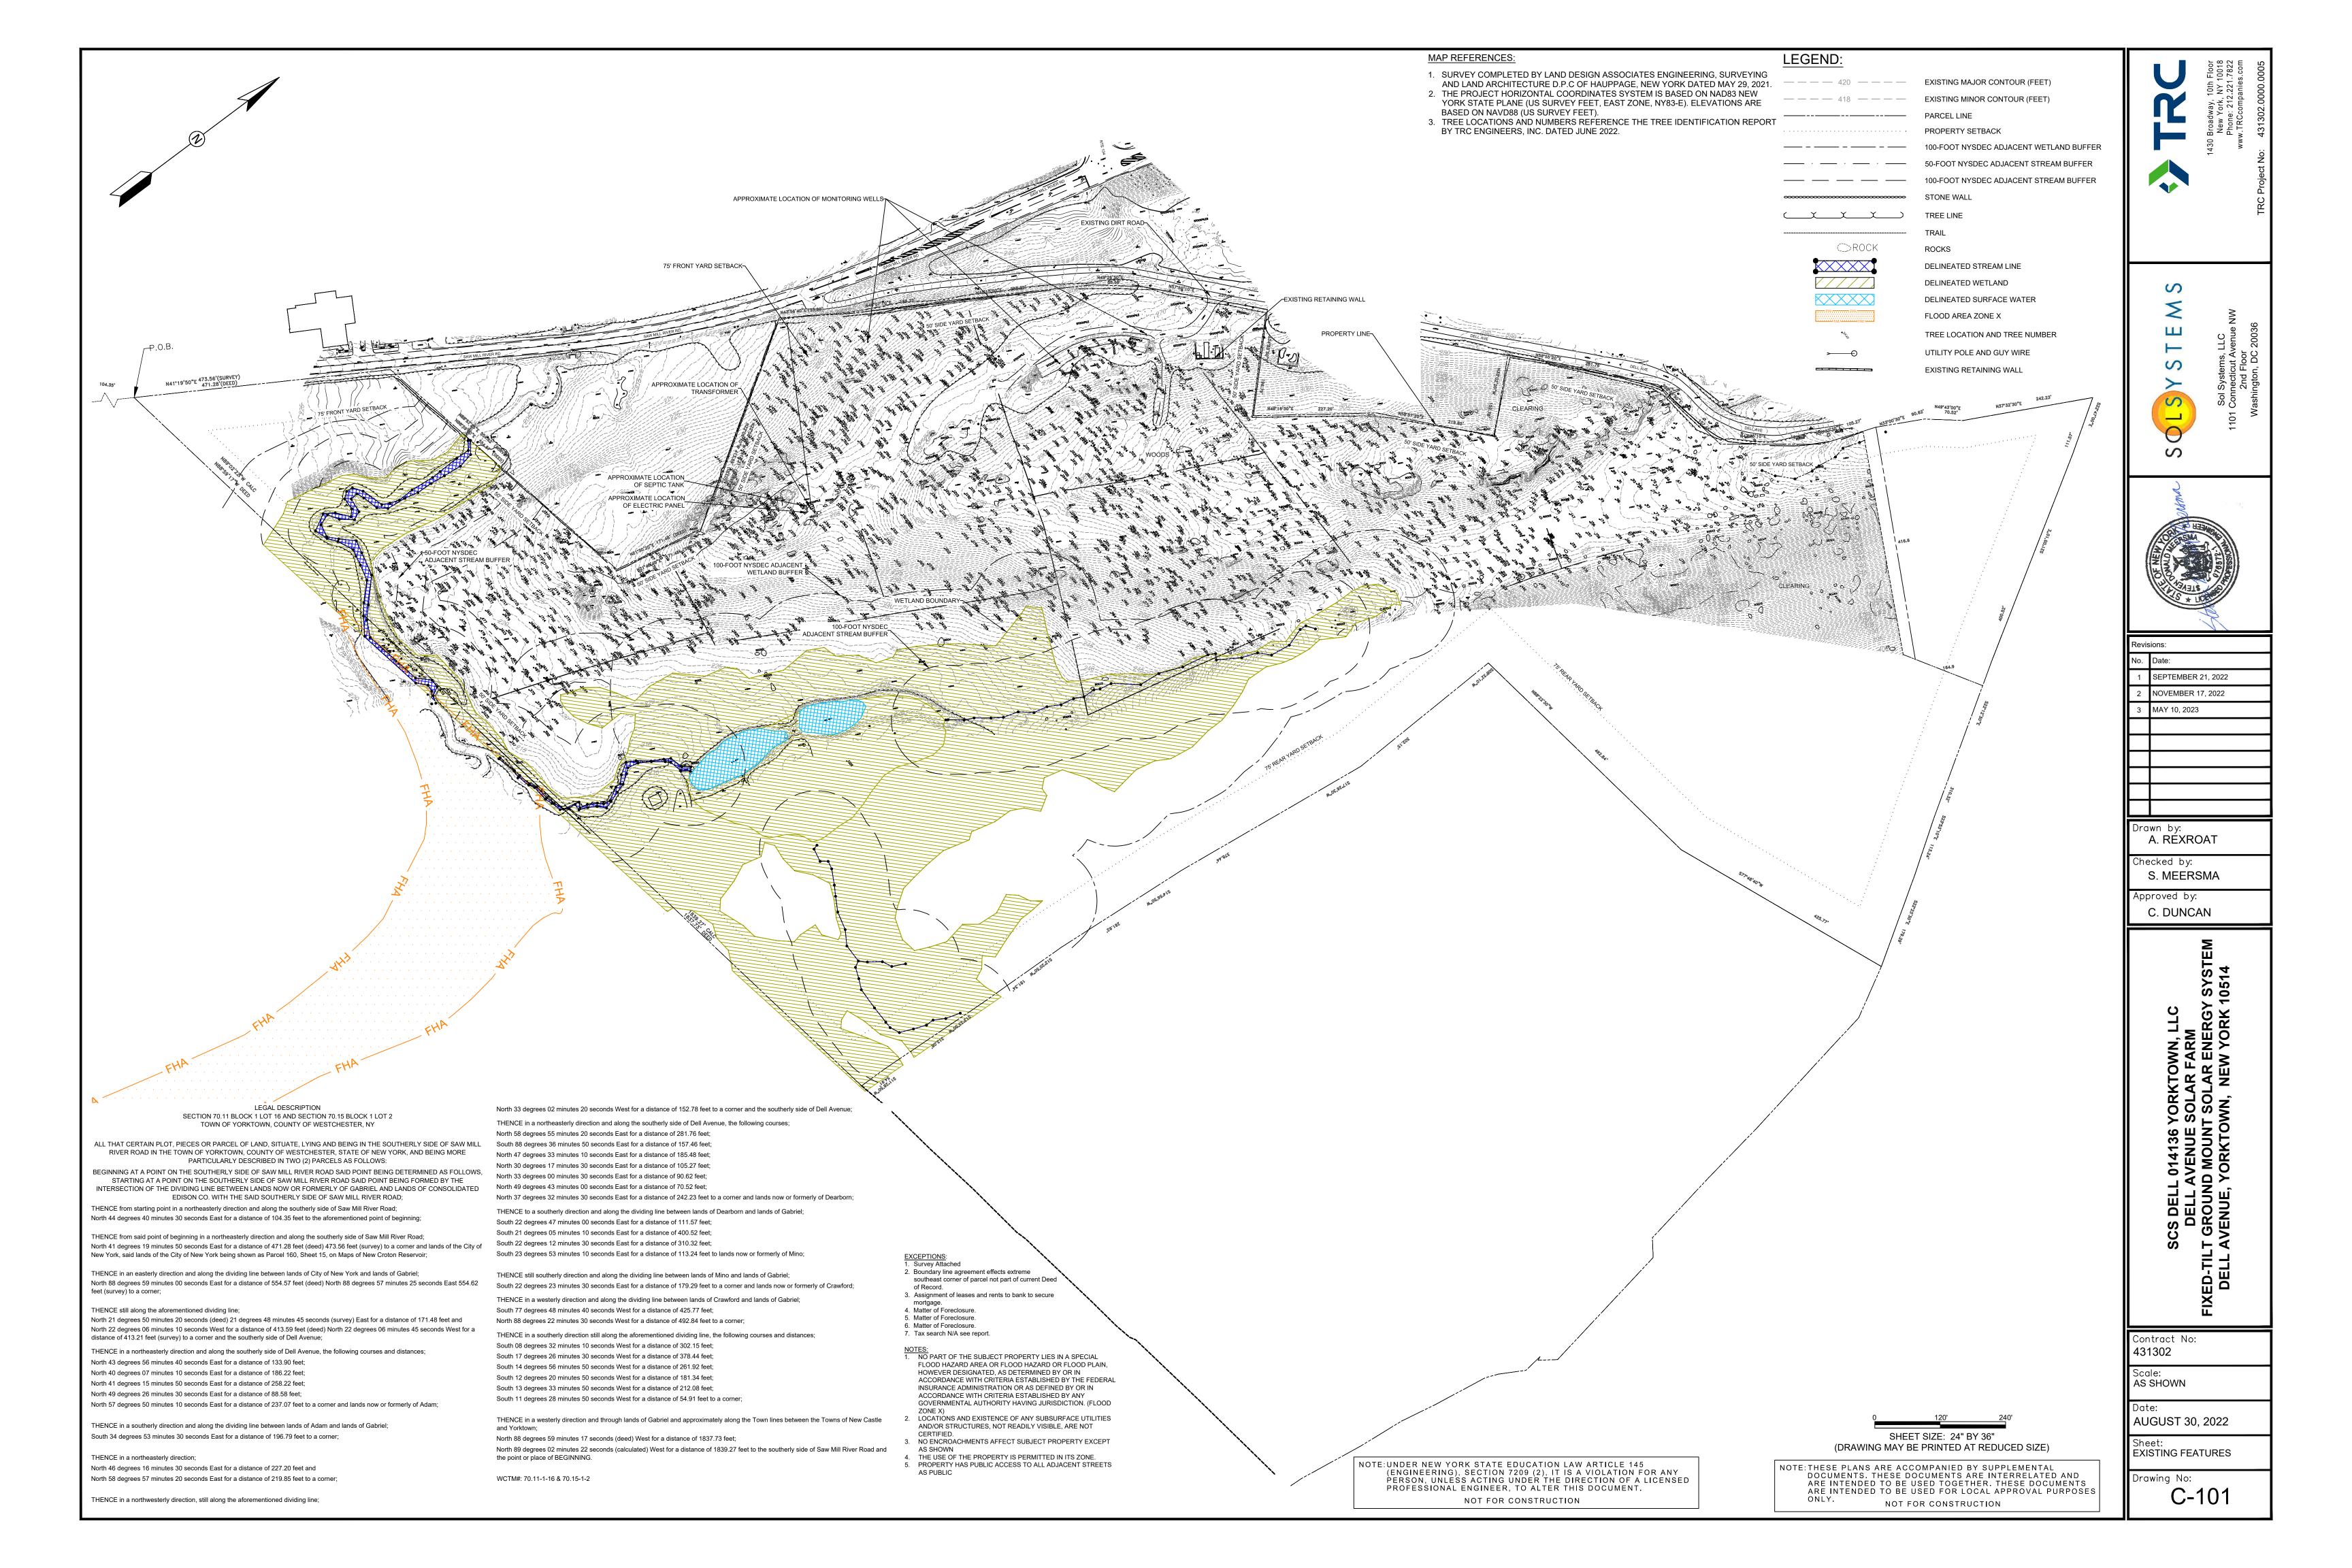

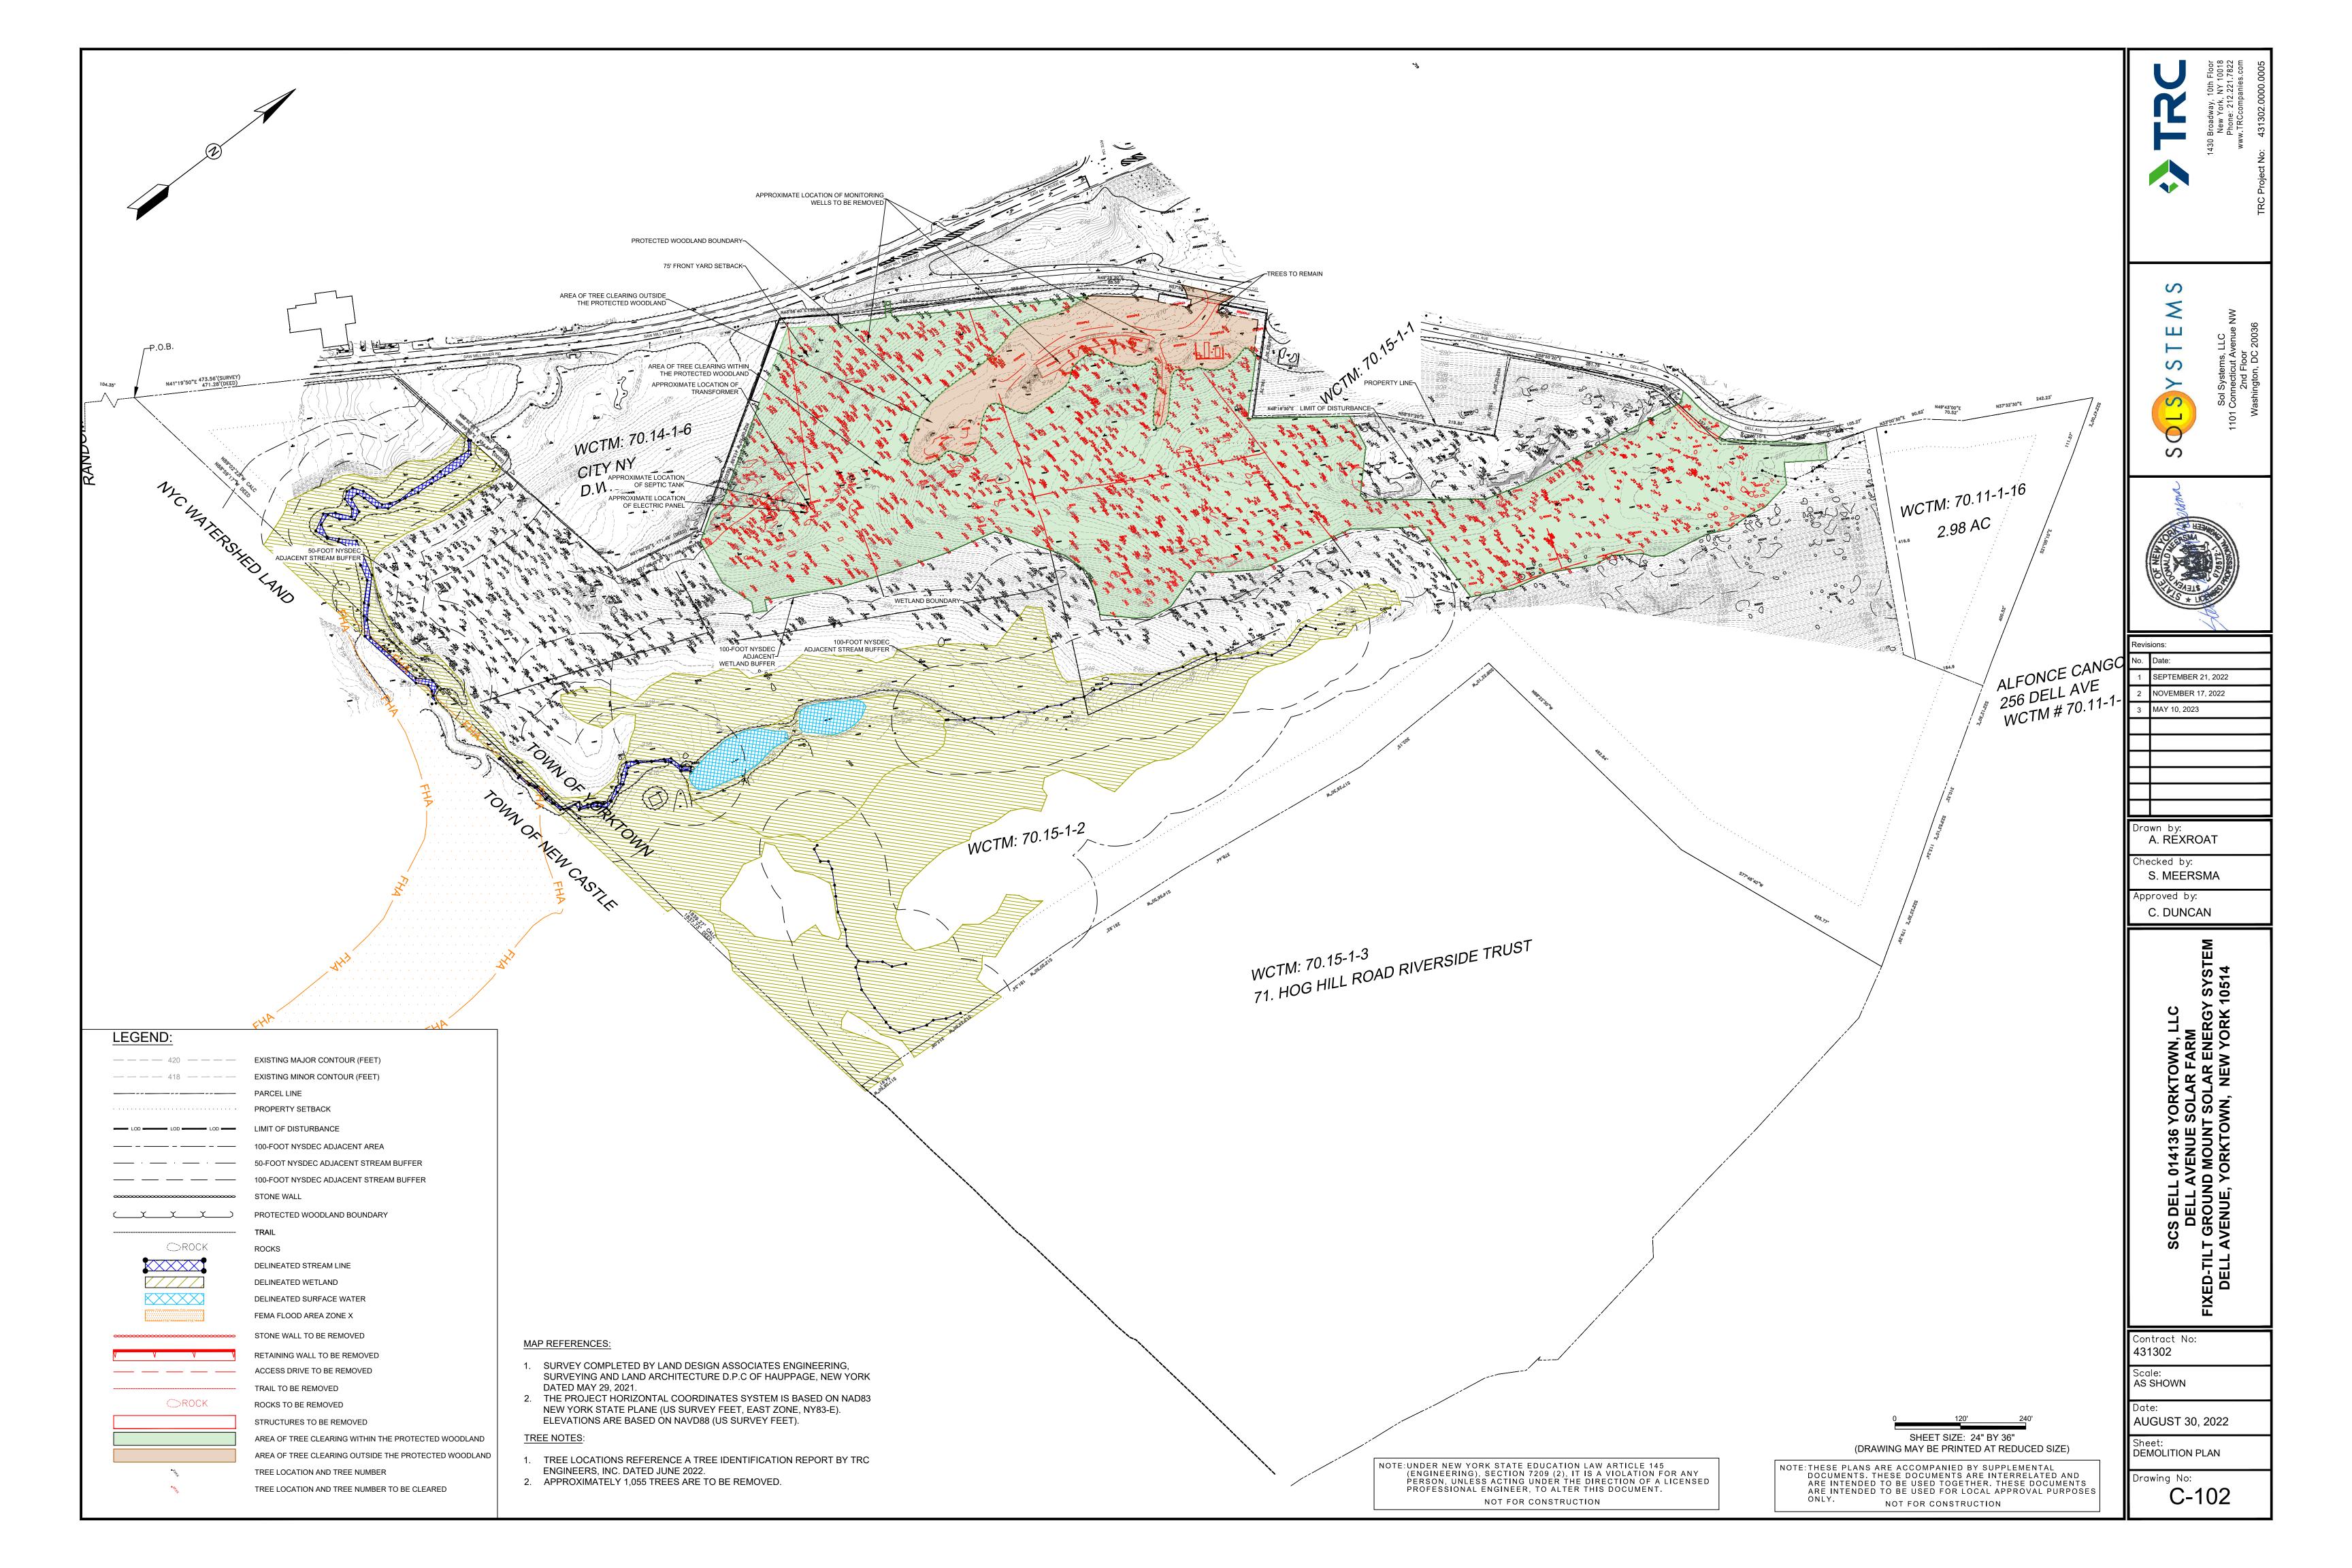

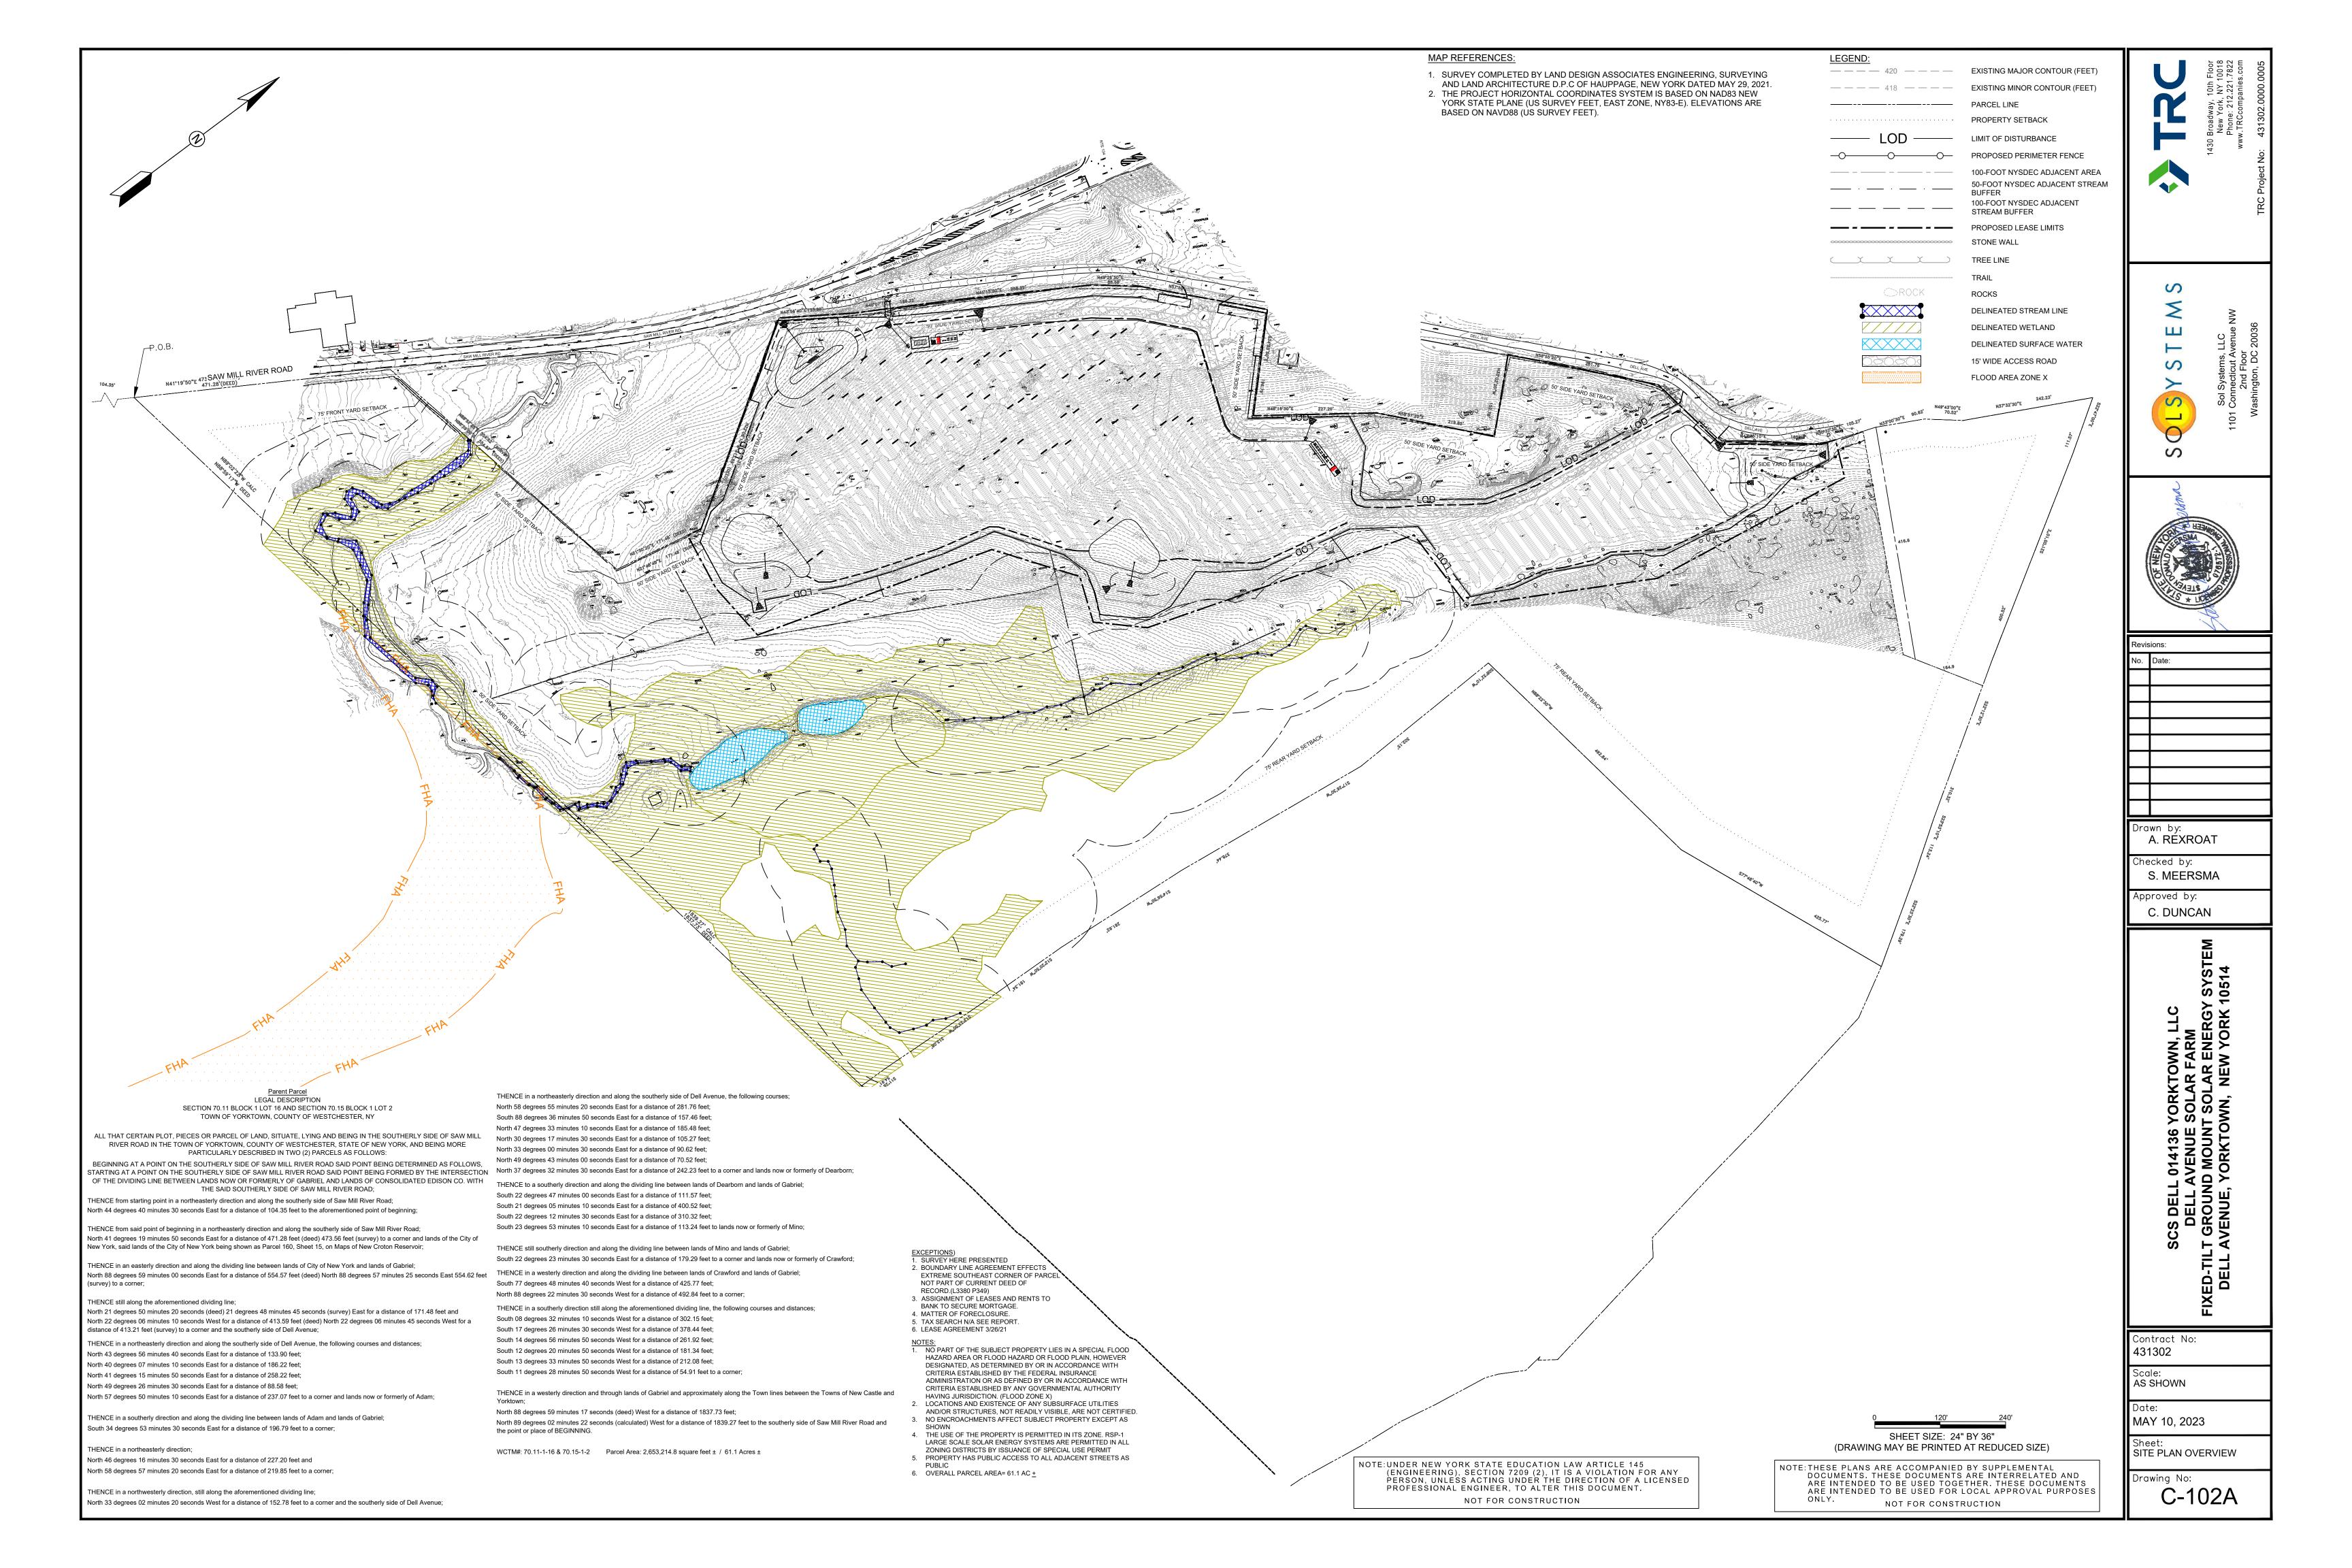

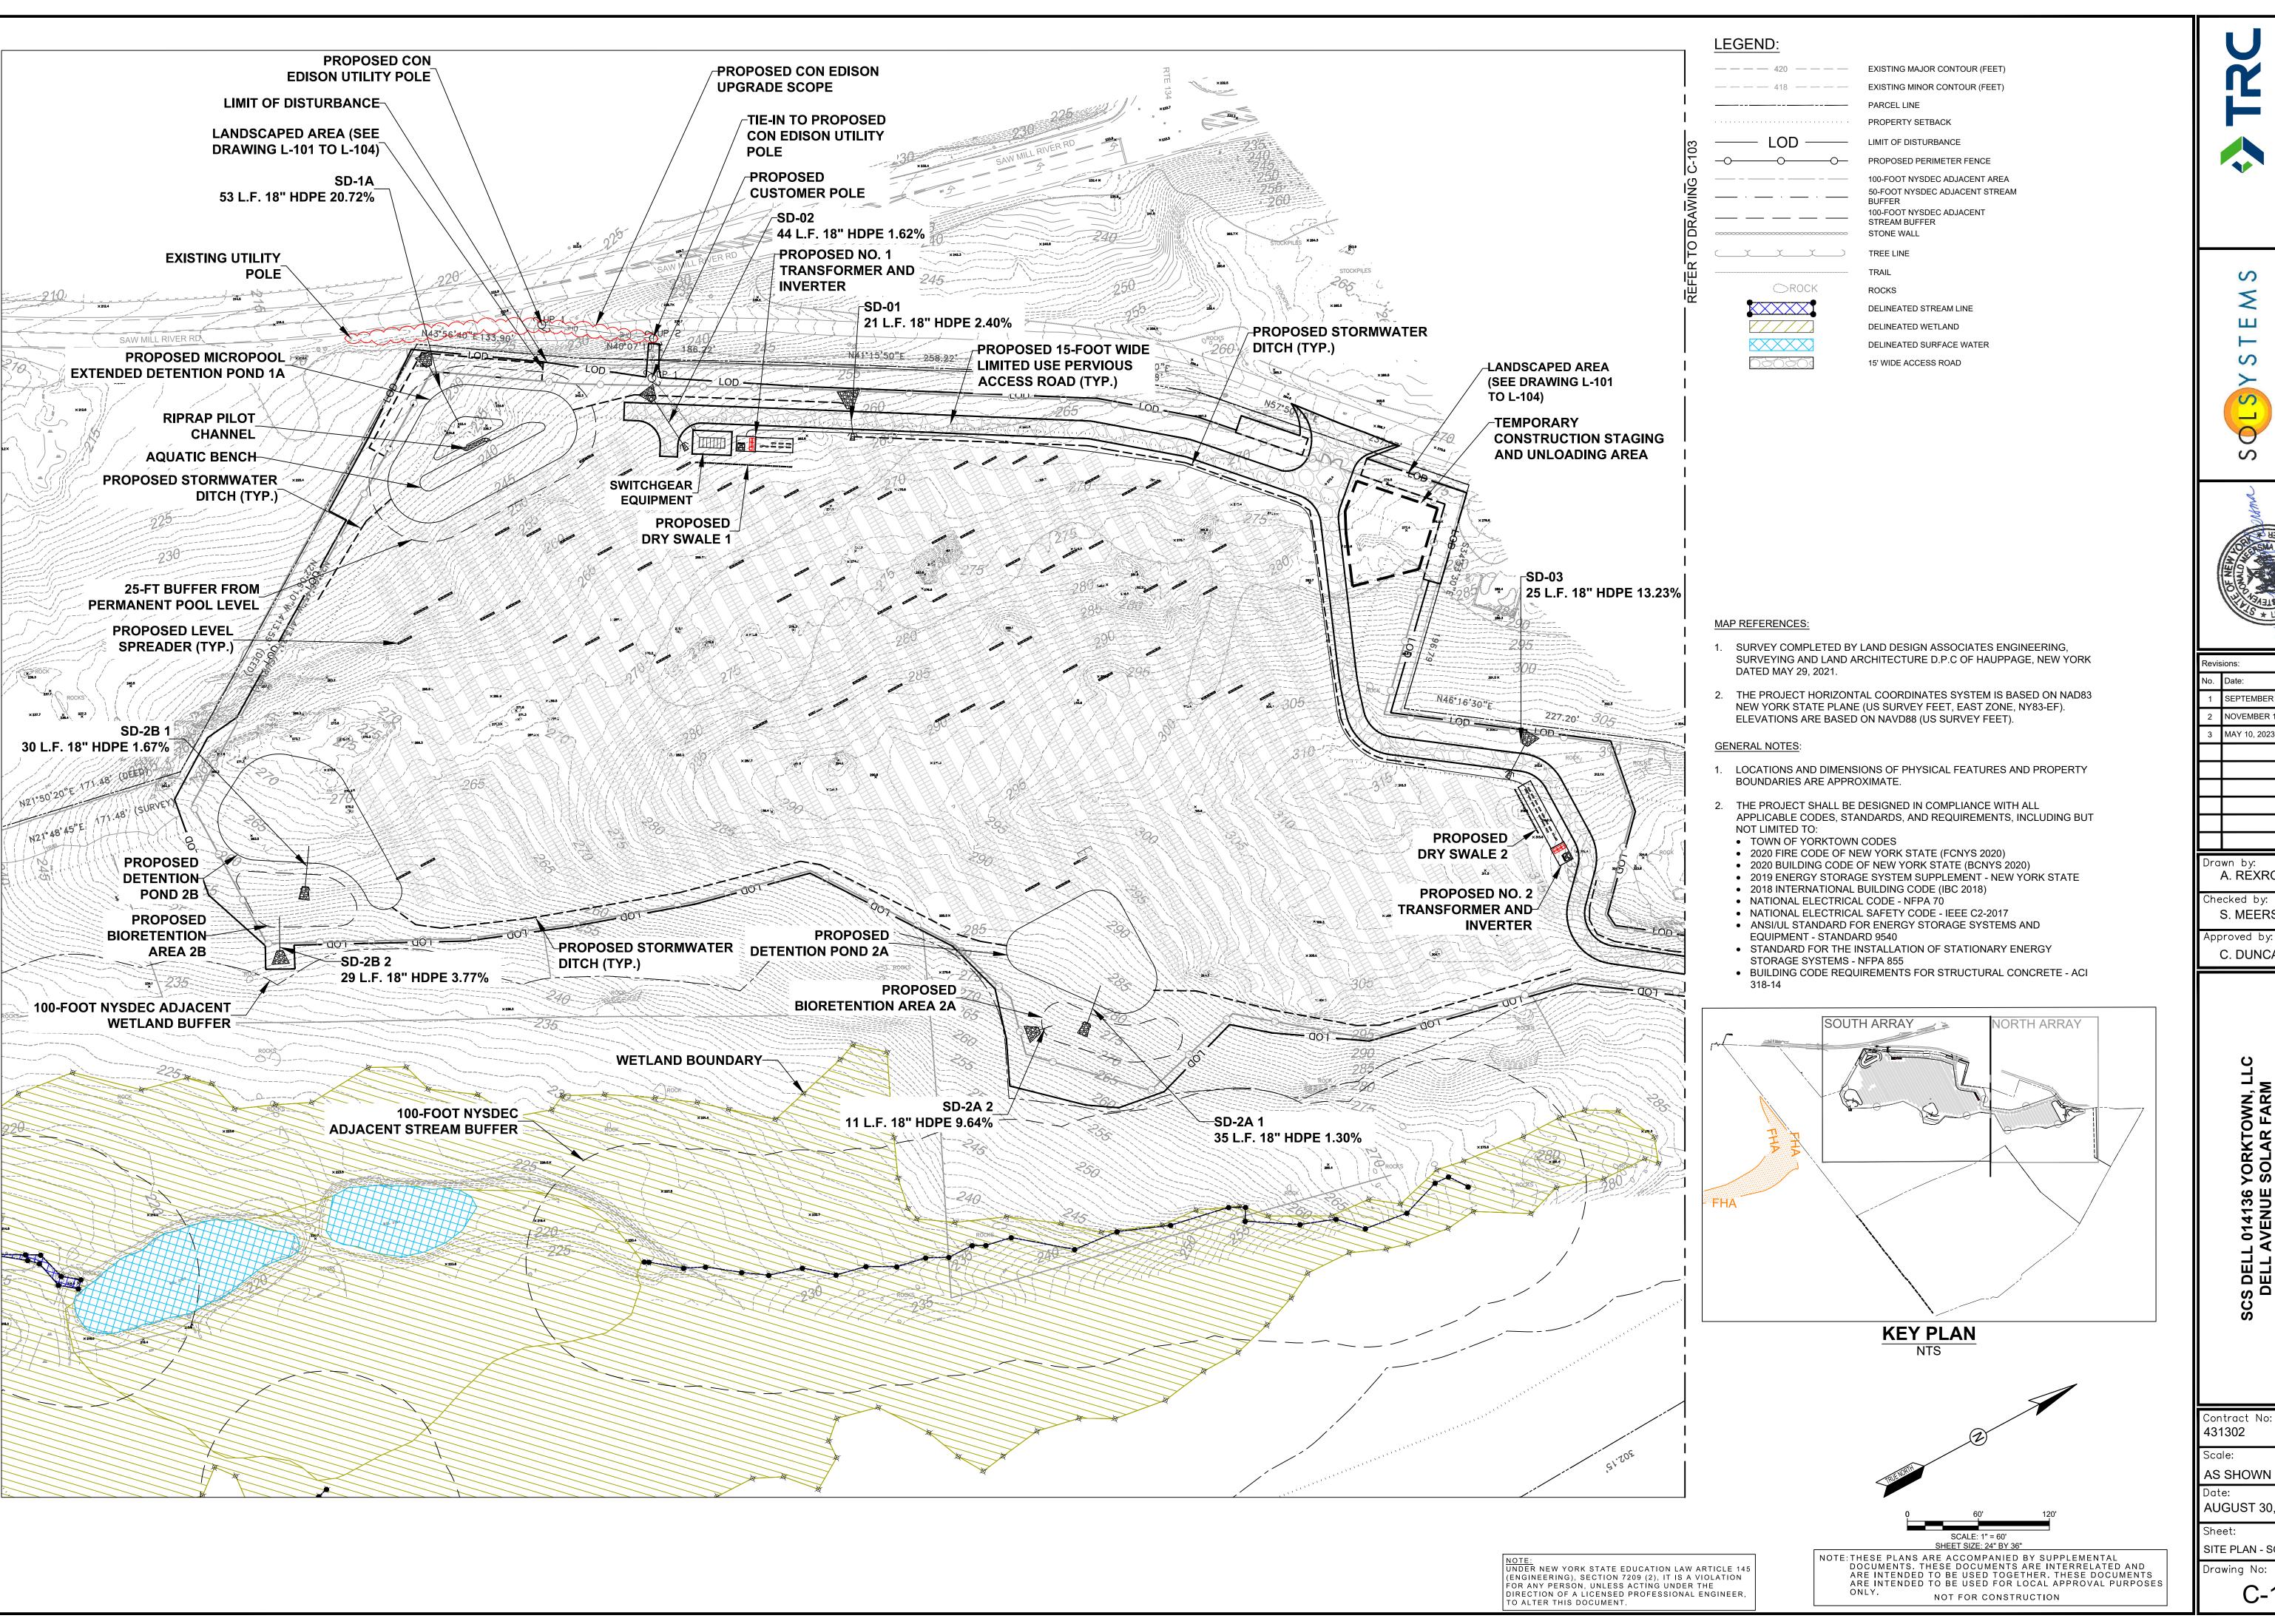



SEPTEMBER 21, 2022 NOVEMBER 17, 2022 MAY 10, 2023

Orawn by:
A. REXROAT

Checked by: S. MEERSMA

Approved by:

C. DUNCAN

431302

AS SHOWN

AUGUST 30, 2022

SITE PLAN - SOUTH